PLANS FOR SANITARY SEWER MAIN

CONSTRUCTION

CONFORMED DOCUMENTS



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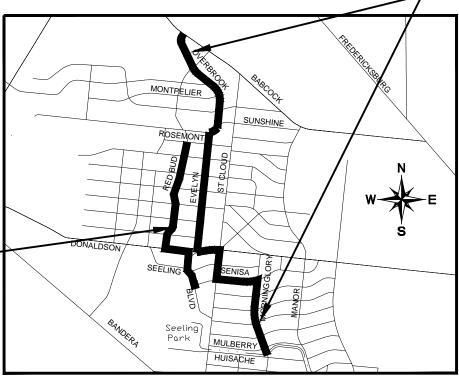
> **PROPOSED ABANDONMENT AND REMOVAL**

C-12 DONALDSON TERRACE **PROJECT**

JOB No. 12-5608 13-2506

MARCH 2019

PROPOSED IMPROVEMENTS



LOCATION MAP

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CIVIL

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30-INCH SANITARY SEWER PLAN AND PROFILE BEGIN TO STA. 4+50

- 30-INCH SANITARY SEWER PLAN & PROFILE STA. 44+00-STA. 48+00 30-INCH SANITARY SEWER PLAN & PROFILE STA. 48+00-STA. 52+00
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AS-BUILT / PLAN OF RECORD

DATE OF COMPLETION: 03-19-2019 03-28-2019 CONTRACTOR: S.J LOUIS CONSTRUCTION OF TEXAS, LTD.

INSPECTOR: RICHARD KER SAWS JOB NO: 13-2506

FRP PIPE: HOBAS PIPE USA PVC PIPE: DIAMOND PLASTICS CORPORATION FRP MANHOLES: L.F. MANUFACTURING, INC. RING AND COVER: EJ USA, INC.

PRECAST MANHOLE: <u>CAPITAL PRECAST</u>
STEEL CASING: <u>PIPE INDUSTRIES CORPORATION</u>

REVISED TO REFLECT CONSTRUCTION RECORDS

THIS RECORD DRAWING SET IS BASED UPON INFORMATION PROVIDED TO KIMLEY-HORN AND ASSOCIATES, INC. (TEXAS REGISTERED FIRM NO. F-928) BY SAWS' PROJECT INSPECTOR AND THE CONTRACTOR, INFORMATION PROVIDED REFLECTS THE CHANGES DURING CONSTRUCTION TO THE PLAN SET USED FOR BIDDING ORIGINALLY SEALED BY JEFFREY A. FARNSWORTH, P.E. NO. 80190

SOLICITATION No. CO-0060

- B. CURRENT SAN ANTONIO WATER SYSTEM "STANDARD SPECIFICATIONS FOR WATER AND SANITARY SEWER CONSTRUCTION."
- C. CURRENT CITY OF SAN ANTONIO "STANDARD SPECIFICATIONS FOR PUBLIC WORKS CONSTRUCTION."
- D. CURRENT CITY OF SAN ANTONIO "UTILITY EXCAVATION CRITERIA MANUAL"
- THE CONTRACTOR IS TO MAKE ARRANGEMENTS WITH THE SAWS CONSTRUCTION INSPECTION DIVISION AT 233-3500 AND PROVIDE NOTIFICATION PROCEDURES THE CONTRACTOR WILL USE TO NOTIFY AFFECTED HOME RESIDENTS AND/OR PROPERTY OWNERS 48 HOURS PRIOR TO EXCAVATION.
- THE CONTRACTOR SHALL VERIFY THE EXACT LOCATION OF UNDERGROUND UTILITIES AND DRAINAGE STRUCTURES AT LEAST 48 HOURS PRIOR TO CONSTRUCTION WHETHER SHOWN ON PLANS OR NOT. THE FOLLOWING CONTACT INFORMATION ARE SUPPLIED FOR VERIFICATION PURPOSES:

UTILITY LOCATE: SAWS UTILITY LOCATES: 233-2009 SAWS PRODUCTION CONTROL CENTER: 233-2016 COSA TRAFFIC SIGNAL OPERATIONS: 207-7720 TEXAS STATE WIDE ONE CALL LOCATOR: 1-800-545-6005 OR 811

- THE CONTRACTOR IS RESPONSIBLE FOR ENSURING THAT NO SANITARY SEWER OVERFLOWS (SSO) OCCUR AS A RESULT OF THEIR WORK. ALL CONTRACTOR PERSONNEL RESPONSIBLE FOR SSO PREVENTION AND CONTROL SHALL BE TRAINED ON PROPER RESPONSE. SHOULD AN SSO OCCUR,
 - A. IDENTIFY THE SOURCE OF THE SSO AND NOTIFY SAWS EMERGENCY OPERATIONS CENTER IMMEDIATELY AT 210-233-2015. PROVIDE THE ADDRESS OF THE SPILL AND AN ESTIMATED VOLUME OR FLOW
 - B. ATTEMPT TO ELIMINATE THE SOURCE OF THE SSO.
 - C. CONTAIN SEWAGE FROM THE SSO TO THE EXTENT POSSIBLE TO PREVENT CONTAMINATION OF
 - D. CLEAN UP THE SPILL SITE (RETURN CONTAINED SEWAGE TO THE COLLECTION SYSTEM IF POSSIBLE) AND DISPOSE OF CONTAMINATED SOIL/MATERIALS.
 - E. CLEAN THE AFFECTED SEWER MAINS AND REMOVE ANY DEBRIS.
 - F. MEET ALL POST-SSO REQUIREMENTS PER THE EPA CONSENT DECREE, INCLUDING LINE CLEANING AND TELEVISING THE AFFECTED SEWER MAINS (AT SAWS DIRECTION) WITHIN 24
 - G. SHOULD THE CONTRACTOR FAIL TO ADDRESS AN SSO IMMEDIATELY AND TO SAWS SATISFACTION, THEY WILL BE RESPONSIBLE FOR ALL ADDITIONAL COSTS INCURRED BY SAWS, INCLUDING ANY FINES FROM THE EPA.
- WHERE NEW SEWER LINES CROSS WATERLINES OR RECLAIMED WATER LINES AND ARE INSTALLED WITH A SEPARATION DISTANCE OF LESS THAN NINE FEET (I.E., WATER/RECLAIMED WATER LINES CROSSING WASTEWATER LINES, WATER/RECLAIMED WATER LINES PARALLELING WASTEWATER LINES, OR WATER/RECLAIMED WATER LINES NEXT TO MANHOLES) THE INSTALLATION MUST MEET THE REQUIREMENTS OF 30 TAC 217.53(D) (PIPE DESIGN), 30 TAC 290.44(E) (WATER DISTRIBUTION), AND 30 TAC 210.25 (SPECIAL DESIGN CRITERIA FOR RECLAIMED WATER SYSTEMS).
- ANY WORK COMPLETED WITHOUT PRIOR AUTHORIZATION WHICH IS NOT INCLUDED IN THESE PLANS AND SPECIFICATIONS WILL NOT BE COMPENSATED BY THE SAN ANTONIO WATER SYSTEM.
- SANITARY SEWER SERVICE LATERAL CONNECTIONS:
 - A. THE EXACT LOCATION AND ELEVATION OF THE SERVICE LATERALS AND MANHOLES SHALL BE FIELD VERIFIED BY THE CONTRACTOR. NO SEPARATE PAY ITEM (N.S.P.I.).
 - B. A MINIMUM OF 3 FEET OF COVER IS TO BE MAINTAINED OVER THE SANITARY SEWER LATERALS AT SUBGRADE.
 - C. ALL SEWER LATERALS SERVICES FOR FUTURE CONNECTIONS AS IDENTIFIED ON THE PLANS SHALL HAVE A ONE WAY CLEAN-OUT, CAPPED AND SEALED.
 - D. THE CONTRACTOR SHALL BE RESPONSIBLE FOR MAINTAINING CONTINUOUS SERVICE DURING CONSTRUCTION OF THE SEWER WORK (N.S.P.I.).
 - E. LATERALS SHALL BE CONSTRUCTED TO SERVE ALL EXISTING HOUSES AND PLATTED VACANT
- THE CONTRACTOR SHALL PROVIDE BYPASS PLIMPING OF SEWAGE AROUND EACH SEGMENT OF PIPE TO BE REPLACED, IN ACCORDANCE WITH SAWS STANDARD SPECIFICATIONS FOR WATER AND SANITARY SEWER CONSTRUCTION ITEM NO. 864, "BYPASS PUMPING". PAYMENT FOR SUCH WORK WILL BE MADE UNDER THE BID ITEM "SANITARY SEWER (BYPASS PUMPING)" AS PER STANDARD SPECIFICATIONS FOR WATER AND SANITARY SEWER CONSTRUCTION ITEM NO. 864. "BYPASS SPECIFICATIONS FOR WATER AND SANITARY SEWER CONSTRUCTION THEM NO. 864, BTFASS PUMPING: THE CONTRACTOR SHALL PROVIDE IN WRITING A SEQUENCE OF BYPASS PUMPING FOR REVIEW AND APPROVAL BY THE INSPECTIONS DEPARTMENT. REFER TO THE CONSTRUCTION PLANS FOR THE CONSTRUCTION PHASING AND DIVERSION REQUIREMENTS. THE CONTRACTOR SHALL ALSO PROVIDE A DETAILED SKETCH SHOWING THE LOCATION OF BYPASS PUMPING EQUIPMENT FOR EACH LINE SEGMENT(S) AROUND WHICH FLOWS ARE BEING BYPASSED, ALONG WITH THE SPECIFICATION OF PUMPING EQUIPMENT, TYPE, SIZE, CAPACITY, AND AMOUNT OF PUMP REQUIRED TO HANDLE THE
- NOTIFY JEFFREY SUPPLEE AT 210-233-3569 A MINIMUM OF 72 HOURS, NOT COUNTING WEEKENDS OR SAWS HOLIDAYS, BEFORE WORKING ON THE PIPE OR MANHOLE, IN ORDER TO HAVE SAWS REMOVE THE SMART COVER/FLOW METER. ANY DAMAGE DONE TO THE SMART COVER/FLOW METER WILL BE CHARGED TO THE CONTRACTOR THROUGH A CHANGE ORDER. 10.
- THE CONTRACTOR SHALL DEWATER ALL TRENCHES IN ACCORDANCE WITH SAWS STANDARD SPECIFICATIONS FOR WATER AND SANITARY SEWER CONSTRUCTION ITEM NO. 804, "EXCAVATION, TRENCHING AND BACKFILL". ALL SUBSURFACE CONDITIONS, INCLUDING BUT NOT LIMITED TO RENORING AND BACKFILL. ALL SUBSURFACE CONDITIONS, INCLUDING BUT NOT LIMITED TO
 GROUNDWATER AND/OR UNSTABLE SOIL CONDITIONS, SHALL BE MITIGATED BY THE CONTRACTOR,
 AS REQUIRED, IN ORDER TO INSTALL THE SANITARY SEWER PER THE SPECIFICATIONS AND THE
 CONTRACT DOCUMENTS. ALL ADDITIONAL WORK REQUIRED TO MEET THE INTENT OF THE SPECIFICATION AND THE CONTRACT DOCUMENTS SHALL BE AT NO ADDITIONAL COST TO SAWS

General Notes

- WITHIN THE LIMITS OF CONSTRUCTION AND/OR ACCESS TO THE PROJECT. THE CONTRACTOR WILL ENCOUNTER TRASH, DEBRIS, DUMPED OBJECTS, AND OTHER WASTE MATERIAL. THE CONTRACTOR WILL BE REQUIRED TO PROPERLY DISPOSE OF THESE MATERIALS AT AN APPROVED LOCATION. THIS WORK SHALL BE CONSIDERED SUBSIDIARY TO THE PROJECT
- THE CONTRACTOR SHALL PROVIDE BYPASS PUMPING IN ACCORDANCE WITH THE REQUIREMENTS OUTLINED IN THESE PLANS AND SPECIFICATIONS
- THE LOCATIONS AND DEPTHS OF EXISTING UTILITIES, INCLUDING SERVICE LATERALS, SHOWN ON THE PLANS ARE APPROXIMATE ONLY. ACTUAL LOCATIONS AND DEPTHS MUST BE FIELD VERIFIED BY THE CONTRACTOR 48 HOURS PRIOR TO CONSTRUCTION AND IT SHALL BE THE CONTRACTOR'S RESPONSIBILITY TO LOCATE UTILITY SERVICE LINES AS REQUIRED FOR CONSTRUCTION AND TO PROTECT THEM DURING CONSTRUCTION AT NO COST TO SAWS.
- THE CONTRACTOR SHALL BE RESPONSIBLE FOR RESTORING ANY DAMAGES DONE TO EXISTING LANDSCAPING AND DRAINAGE INLETS TO THE ORIGINAL CONDITION OR BETTER AT NO ADDITIONAL COST TO SAWS
- THE CONTRACTOR SHALL AVOID CUTTING ROOTS LARGER THAN ONE INCH IN DIAMETER THE CONTRACTOR SHALL AVOID CUTTING ROUTS LARGER THAN ONE INCH IN DIAMETER WHEN EXCAVATING NEAR EXISTING TREES, EXCAVATION IN VICINITY OF TREES SHALL PROCEED WITH CAUTION, THE CONTRACTOR SHALL CONTACT THE CITY ARBORIST AT 207—0278 FOR GUIDANCE. THE SAWS INSPECTOR SHALL ALSO BE NOTIFIED, TRIMMING AND ANY OTHER ADJUSTMENTS TO EXISTING TREES SHALL BE PERFORMED TO THE SATISFACTION
- PRIOR TO TIE-INS, ANY SHUTDOWNS OF EXISTING MAINS OF ANY SIZE MUST BE COORDINATED WITH THE SAWS CONSTRUCTION INSPECTION DIVISION AT (210)233-3500 AND/OR SAWS PRODUCTION GROUPS AT LEAST TWO WEEKS IN ADVANCE OF THE SHUTDOWN. THE CONTRACTOR MUST ALSO PROVIDE A SEQUENCE OF WORK AS RELATED TO THE TIE-INS; THIS IS AT NO ADDITIONAL COST TO SAWS OR THE PROJECT AND IT IS THE RESPONSIBILITY OF THE CONTRACTOR TO SEQUENCE THE WORK ACCORDINGLY.
- CONTRACTOR AGREES THAT HE SHALL ASSUME SOLE AND COMPLETE RESPONSIBILITY FOR JOB SITE CONDITIONS DURING THE CONSTRUCTION OF THE PROJECT, INCLUDING SAFETY OF ALL PERSONS AND PROPERTY; THAT THIS REQUIREMENT SHALL APPLY CONTINUOUSLY AND NOT BE LIMITED TO NORMAL WORKING HOURS; AND THAT THE CONTRACTOR SHALL DEFEND, INDEMNIFY AND HOLD SAWS AND THE CONSULTANT HARMLESS FROM ANY AND ALL LIABILITY, REAL OR ALLEGED, IN CONNECTION WITH THE PERFORMANCE OF THE WORK ON THIS PROJECT, EXCEPTING FROM LIABILITY ARISING FROM SOLE NEGLIGENCE OF SAWS OR
- CONTRACTOR IS REQUIRED TO VERIFY PROJECT ELEVATIONS. "MATCH EXISTING" SHALL BE UNDERSTOOD TO SIGNIFY VERTICAL AND HORIZONTAL ALIGNMENT.
- THE CONTRACTOR SHALL FURNISH ALL ASSISTANCE REQUIRED OF HIM BY ALL INSPECTORS IN OBTAINING SAMPLES AT THE EXPENSE OF THE CONTRACTOR.
- CONTRACTOR TO PERFORM ALL TESTS REQUIRED BY SAWS AND TCEQ. ADDITIONAL TESTS WILL BE DONE BY TV CAMERA BY THE CONTRACTOR AND OBSERVED BY INSPECTOR, AND SAWS' WASTEWATER ENGINEERING PERSONNEL, AS THE CAMERA IS RUN THROUGH THE LINES. ANY ABNORMALITIES, SUCH AS BROKEN PIPE OR MISALIGNED JOINTS, MUST BE REPLACED BY THE CONTRACTOR AT HIS EXPENSE, CONTRACTOR TO PROVIDE TV TAPES TO CONSTRUCTION INSPECTION FOR REVIEW PRIOR TO FINAL INSPECTION OF THE PROJECT.
- CONNECTION OF EXISTING SANITARY SEWERS TO PROPOSED MANHOLES AND CONNECTION OF PROPOSED SANITARY SEWERS TO EXISTING MANHOLES SHALL BE SUBSIDIARY TO THE COST OF THE PROJECT (NO SEPARATE PAY ITEM).
- REMOVAL OF EXISTING SEWER LINES TO BE REPLACED WITH PROPOSED LINES IN THE SAME TRENCH AT THE SAME OR SHALLOWER GRADE SHALL BE SUBSIDIARY TO THE COST OF THE PROPOSED SEWER LINES (NO SEPARATE PAY ITEM).
- THE CONTRACTOR SHALL MAINTAIN SERVICE TO EXISTING SANITARY SEWERS AT ALL TIMES DURING CONSTRUCTION.
- ELECTRICAL LINES ARE LOCATED IN THE PROJECT AREA. THE ATTENTION OF THE CONTRACTOR IS DIRECTED TO STATE LAW (HEALTH AND SAFETY CODE, TITLE 9, SUBTITLE A, CHAPTER 752) CONCERNING CONSTRUCTION OPERATIONS IN THE VICINITY OF ELECTRICAL LINES AND THE NEED FOR EFFECTIVE PRECAUTIONARY MEASURES.
- CONTRACTOR SHALL MAINTAIN ACCESS TO PUBLIC AND PRIVATE FACILITIES DURING CONSTRUCTION. CONSTRUCTION ACTIVITIES SHALL BE COORDINATED WITH OWNER'S REPRESENTATIVE AND SAN ANTONIO WATER SYSTEM.
- THESE PLANS, PREPARED BY KIMLEY—HORN AND ASSOCIATES, INC. DO NOT EXTEND TO OR INCLUDE DESIGNS OR SYSTEMS PERTAINING TO THE SAFETY OF THE CONSTRUCTION CONTRACTOR OR ITS EMPLOYEES, AGENTS OR REPRESENTATIVES IN THE PERFORMANCE OF THE WORK. THE SEAL OF KIMLEY—HORN AND ASSOCIATES, INC.'S LICENSED PROFESSIONAL ENCINEER(S) HEREON DOES NOT EXTEND TO ANY SUCH SAFETY SYSTEMS THAT MAY NOW OR HEREAFTER BE INCORPORATED INTO THE WORK. THE CONSTRUCTION CONTRACTOR SHALL PREPARE OR OBTAIN THE APPROPRIATE SAFETY SYSTEMS.
- CONTRACTOR TO ASSURE HIMSELF THAT ALL CONSTRUCTION PERMITS HAVE BEEN OBTAINED PRIOR TO COMMENCEMENT OR WORK. REQUIRED PERMITS THAT CAN ONLY BE ISSUED TO CONTRACTOR ARE TO BE OBTAINED AT THE CONTRACTORS EXPENSE.
- 18. CONTRACTOR SHALL COORDINATE INTERRUPTIONS OF ALL UTILITIES AND SERVICES WITH APPLICABLE UTILITY COMPANY OR COMPANIES. ALL WORK TO BE IN ACCORDANCE WITH THE REQUIREMENTS OF THE APPLICABLE UTILITY COMPANY OR AGENCY INVOLVED.
- CONTRACTOR SHALL LOCATE, PROTECT, AND MAINTAIN BENCHMARKS, MONUMENTS, AND CONTROL POINTS. RE-ESTABLISH DISTURBED OR DESTROYED ITEMS BY REGISTERED PUBLIC SURVEYOR IN THE STATE OF TEXAS AT NO ADDITIONAL COST TO SAWS.
- EXISTING PAVING, BUILDINGS, AND OTHER ITEMS SHOWN ON PLANS NOT SPECIFICALLY RELATED TO THE WORK OF THE CONTRACT ARE FOR INFORMATIONAL PURPOSES ONLY.
- ANY CHANGES OR REVISIONS TO THESE PLANS MUST FIRST BE SUBMITTED TO SAWS FOR REVIEW AND WRITTEN APPROVAL.

- NO SEPARATE PAY FOR ITEMS REQUIRED BY NOTES ON THIS SHEET, UNLESS INCLUDED ON
- 23. ASBESTOS CEMENT (AC) PIPE, ALSO KNOW AS TRANSITE PIPE WHICH IS KNOWN TO CONTAIN ASBESTOS—CONTAINING MATERIAL (ACM), MAY BE LOCATED WITHIN THE PROJECT LIMITS. SPECIAL WASTE MANAGEMENT PROCEDURES AND HEALTH AND SAFETY REQUIREMENTS FOR SUCH WORK IS TO BE MADE UNDER SPECIAL SPECIFICATION ITEM FOR ASBESTOS CEMENT
- THE SAWS INSPECTOR WILL ADDRESS ALL LIMITS FOR CURB, SIDEWALK, AND TREE PROTECTION BEYOND WHAT IS CONSIDERED INCIDENTAL TO NORMAL UTILITY CONSTRUCTION. ALL COMMUNICATION FROM THE CITY WILL BE COORDINATED THROUGH THE SAWS INSPECTOR. SAWS INSPECTOR WILL DETERMINE IF ADDITIONAL COMPENSATION IS WARRANTED IF LIMITS EXCEED INCIDENTALS.
- 25. CONTRACTOR SHALL BE AWARE THAT EXISTING UTILITIES MAY IMPACT THE METHOD OF TRENCHLESS INSTALLATION. THE INTENT IS FOR THE CONTRACTOR TO USE A MEANS OF JACKING, BORING, OR TUNNELING TO FIT IN THE FOOTPRINT AVAILABLE.
- IN ALL AREAS WHERE AN EXISTING PAVED SURFACE (SUCH AS A ROADWAY, DRIVEWAY, OR SIDEWALK) ARE TO BE IMPACTED BY CONSTRUCTION. THE CONTRACTOR SHALL SAW-CUT THE PAVED SURFACE, ASSURING CLEAN & STRAIGHT CUT TO FULL DEPTH OF THE PAVED
- 27. IN ALL AREAS WHERE SIDEWALK, CURB, OR DRIVEWAY IS TO BE REPLACED, THE CONTRACTOR SHALL REMOVE AT NEAREST JOINT (N.S.P.I.).
- 28. CONTRACTOR MAY ENCOUNTER CONCRETE ENCASEMENT IN THE IMMEDIATE VICINITY OF EXISTING MANHOLES. ANY CONCRETE REMOVAL REQUIRED FOR THE PROPER INSTALLATION OF PROPOSED SEWER MAIN AND TIE-INS SHALL BE AT NO ADDITIONAL COST TO THE
- 29. ALL SANITARY SEWER MANHOLES SHALL BE WATERTIGHT.
- ALL ROADWAYS WITH LANE STRIPING SHALL BE RE-STRIPED TO MATCH THE EXISTING
- ALL ROADS WITH 4 INCH WHITE BROKEN LINES AND REFLECTORS SHALL BE RE-STRIPED IN ACCORDANCE WITH TXDOT ITEM 666 2003.

TRAFFIC CONTROL

32. BARRICADES AND WARNING SIGNS SHALL CONFORM TO THE CURRENT TEXAS MANUAL ON UNIFORM TRAFFIC CONTROL DEVICES AND ARE TO BE GENERALLY LOCATED TO AFFORD MAXIMUM PROTECTION TO THE PUBLIC AS WELL AS CONSTRUCTION PERSONNEL AND EQUIPMENT AND TO ASSURE AN EXPEDITIOUS TRAFFIC FLOW AT ALL TIMES. DURING THE PROGRESS OF WORK, THE CONTRACTOR SHALL PROVIDE ACCESS FOR LOCAL TRAFFIC.

NON-STANDARD WORKING HOURS

NO ADDITIONAL COMPENSATION WILL BE ALLOWED FOR WORK OUTSIDE OF STANDARD WORKING HOURS. WORK OUTSIDE OF STANDARD WORKING HOURS SHALL BE CONSIDERED SUBSIDIARY TO THE PROJECT.

EXCAVATION

- 34. CONTRACTOR AND/OR CONTRACTOR'S INDEPENDENTLY RETAINED EMPLOYEE OR STRUCTURAL DESIGN/GEOTECHNICAL/SAFETY/EQUIPMENT CONSULTANT, IF ANY, SHALL REVIEW THESE PLANS AND AVAILABLE GEOTECHNICAL INFORMATION AND THE ANTICIPATED INSTALLATION SITE(S) WITHIN THE PROJECT WORK AREAS IN ORDER TO IMPLEMENT CONTRACTOR'S TRENCH EXCAVATION SAFETY PROTECTION SYSTEMS, PROGRAMS AND/OR PROCEDURES. THE CONTRACTOR'S IMPLEMENTATION OF THE SYSTEMS, PROGRAMS AND/OR PROCEDURES SHALL PROVIDE FOR ADEQUATE TRENCH EXCAVATION SAFETY PROTECTION THAT COMPLIES WITH AS A MINIMUM, OSHA STANDARDS FOR TRENCH EXCAVATIONS. SPECIFICALLY, CONTRACTOR AMD/OR CONTRACTOR'S INDEPENDENTLY RETAINED EMPLOYEE OR SAFETY CONSULTANT SHALL IMPLEMENT A TRENCH SAFETY PROGRAM IN ACCORDANCE WITH OSHA STANDARDS GOVERNING THE PRESENCE AND ACTIVITIES OF INDIVIDUALS WORKING IN AND AROUND TRENCH EXCAVATION.
- THE CONTRACTOR SHALL COMPLY WITH THE APPROVED COSA FLOODPLAIN PERMIT. THE CONTRACTOR IS RESPONSIBLE FOR THE REMOVAL OF ALL WASTE MATERIALS UPON PROJECT COMPLETION.

36. THE CONTRACTOR SHALL SECURE ALL BORE AREAS AND RECEIVING PITS WITH SECURITY FENCING AND ALL PROPER SAFETY MEASURES (N.S.PI.).

THE CONTRACTOR SHALL MAINTAIN A NEAT AND ACCURATE RECORD OF CONSTRUCTION FOR THE ENGINEER'S RECORDS. THE CONTRACTOR SHALL PROVIDE ENGINEER WITH FULL SIZE REPRODUCIBLE MARKUPS THAT RECORD ALL CONSTRUCTION DEVIATING FROM THE PLANS.

ABANDONMENT/REMOVAL OF OLD MAINS AND MANHOLES

- ABANDONMENT OF SANITARY SEWER MAINS AND MANHOLES SHALL BE IN ACCORDANCE WITH SAWS SPECIFICATION NO. 862.
- WHERE EXISTING SEWER LINES TO BE REPLACED BY PROPOSED LINES ARE PARTIALLY IN THE PROPOSED TRENCH, OR COMPLETELY OUT OF THE PROPOSED TRENCH, THE EXISTING SEWER SHALL BE ABANDONED AND PAID FOR IN ACCORDANCE WITH SAWS STANDARD SPECIFICATIONS FOR WATER & SANITARY SEWER CONSTRUCTION ITEM NO. 862, "ABANDONMENT OF SEWER MAINS AND MANHOLES". IN LOCATIONS WHERE THE EXISTING SANITARY SEWER LINES ARE PARTIALLY WITHIN THE TRENCH AND REQUIRE ABANDONMEN THE CONTRACTOR WILL BE REQUIRED TO MAKE ALL NECESSARY ADDITIONAL PAVEMENT REPLACEMENT AT NO ADDITIONAL COST (NO SEPARATE PAY ITEM).

AS-BUILT / PLAN OF RECORD DATE OF COMPLETION: 03-19-2019 CONTRACTOR: S.J LOUIS CONSTRUCTION OF TEXAS, LTD. INSPECTOR: RICHARD KER SAWS JOB NO: <u>13-2506</u>

REVISED TO REFLECT CONSTRUCTION RECORDS

THIS RECORD DRAWING SET IS BASED UPON INFORMATION PROVIDED TO KIMLEY-HORN AND ASSOCIATES, INC. (TEXAS REGISTERED FIRM NO. E-928) BY SAWS' PROJECT INSPECTOR AND THE CONTRACTOR. INFORMATION PROVIDED REFLECTS THE CHANGES DURING CONSTRUCTION TO THE PLAN SET USED FOR BIDDING ORIGINALLY SEALED BY JEFFREY A. FARNSWORTH, P.E. NO. 80190

THIS CONSTRUCTION DOCUMENT WAS PREPARED USING INFORMATION SUPPLIED BY THE CONTRACTOR TO PEPPRESENT CONSTRUCTION CHARGES

DATE: 03-19-2019

Kimley » Horn

Tel No. 210-541-9166

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601 NW Loop 410 Suite 350

No. Revision By Date



C-12 DONALDSON TERRACE PROJECT SHEET

GENERAL NOTES (SHEET 1 OF 2)

DATE: MARCH 2019 SAWS PROJECT NO. DESIGN: JAF 13-2506 DRAWN: ABC KHA PROJECT NO. CHECKED: VRS 068665011

General Notes (Cont.)

SUPPLEMENTARY

- 40. ALL ASTM D-3754 SANITARY SEWER PIPE SHALL HAVE A MINIMUM PRESSURE RATING OF 150 PSI.
- NO EXTRA-PAYMENT SHALL BE ALLOWED FOR WORK CALLED FOR ON THE PLANS BUT NOT INCLUDED ON THE BID SCHEDULE. THIS INCIDENTAL WORK WILL BE REQUIRED AND SHALL BE INCLUDED UNDER THE PAY ITEM TO WHICH IT RELATES.
- 42. WORK COMPLETED BY THE CONTRACTOR WHICH HAS NOT RECEIVED A WORK ORDER OR THE NOTICE TO PROCEED FROM THE ENGINEER AND INSPECTOR WILL BE SUBJECT TO REMOVAL AND REPLACEMENT BY AND AT THE EXPENSE OF THE CONTRACTOR.
- 43. NO MORE THAN 200 LINEAR FEET OF TRENCH EXCAVATION IN ADVANCE OF THE UTILITY WILL BE ALLOWED AT A TIME.
- 44. INSPECTOR MUST CALL FOR BACKFILL INSPECTIONS.
- 45. DENSITY REPORTS MUST BE SUBMITTED TO THE INSPECTOR WITHIN 24 HOURS OF TESTING.

CPS ENERGY NOTE:

- 46. CALL CPS LOCATOR AT 978-3500 48 HOURS BEFORE BEGINNING ANY EXCAVATION.
- THE CONTRACTOR WILL BE RESPONSIBLE FOR PROTECTING CPS ENERGY OVERHEAD AND UNDERGROUND ELECTRIC FACILITIES IF ADJACENT TO WORK AREAS.
- DUE TO FEDERAL REGULATIONS TITLE 49, PART 192.181, CPS ENERGY MUST MAINTAIN ACCESS TO GAS VALVES AT ALL TIMES. THE CONTRACTOR MUST PROTECT AND WORK AROUND CPS VALVES THAT ARE IN THE PROJECT AREA.
- 49. CONTRACTOR SHALL BE RESPONSIBLE FOR COORDINATING WITH CPS TO BRACE POWER POLES.
 ANY POLES WITHIN 10 FEET OF CONSTRUCTION SHALL BE REVIEWED WITH CPS TO DETERMINE IF BRACING IS REQUIRED (NO SEPARATE PAY ITEM).

AT&T:

THE CONTRACTOR SHOULD CALL FOR LOCATES THROUGH THE "ONE CALL" UTILITY LOCATE SERVICE (1-800-344-8377) 48 HOURS PRIOR TO CONSTRUCTION/EXCAVATION WORK. CONTRACTORS HAVE THE RESPONSIBILITY TO PROTECT AND SUPPORT TELEPHONE COMPANY PLANT DURING CONSTRUCTION.

GENERAL SEWER NOTES:

- 51. CONTRACTOR IS RESPONSIBLE TO SUPPORT AND PROTECT ANY EXISTING UTILITIES ADJACENT TO WORK AREA (NO SEPARATE PAY ITEM).
- ALL GRADES ARE CALCULATED TO THE CENTERLINE OF MANHOLE FOR MANHOLES WITH A 0.1 FOOT DROP. MANHOLES WITH POINT OF INTERSECTION SHALL HAVE 0.1 FOOT DROP PLUS INCREASE FOR PIPE GRADES. RESULTING DROP BETWEEN PIPES ACROSS ENTIRE MANHOLE WILL BE THE SUM OF THE 0.1 FOOT DROP AND THE TWO INTERSECTION PIPE GRADES MULTIPLIED BY THE RADIUS FOR ALL MANHOLES SPECIFIED IN THE PLANS TO HAVE A DROP. (TOTAL DROP ACROSS MANHOLE = 0.1 + GRADE1(R) + GRADE2(R))

STORM WATER POLLUTION PREVENTION PLAN (SWPPP)

- 53. A CONSTRUCTION SITE NOTICE SHALL BE POSTED BY THE CONTRACTOR PRIOR TO COMMENCEMENT OF CONSTRUCTION ACTIVITIES.
- ALL CONTRACTORS AND SUBCONTRACTORS PROVIDING SERVICES RELATED TO THE SWPPP SHALL SIGN A CONTRACTOR CERTIFICATION STATEMENT ACKNOWLEDGING THEIR RESPONSIBILITY AS SPECIFIED IN THE SWPPP.
- 55. A COPY OF THE SWPPP, INCLUDING CONTRACTOR CERTIFICATIONS AND ANY REVISIONS, SHALL BE SUBMITTED TO THE CITY AND FILED WITH THE CONSTRUCTION PLANS, AND SHALL BE RETAINED ON—SITE DURING CONSTRUCTION.
- 56. A NOTICE OF TERMINATION (N.O.T.) SHALL BE SUBMITTED TO THE TCEQ BY THE CONTRACTOR WHEN THE SITE HAS 100% OF THE DISTURBED AREAS STABILIZED AND THE SITE NO LONGER HAS STORM WATER DISCHARGES ASSOCIATED WITH CONSTRUCTION ACTIVITIES, OR THE N.O.T. PERMITTEE OR CO-PREMITTEE
- 57. CONTRACTOR SHALL BE RESPONSIBLE FOR PREPARING, SUBMITTING, AND POSTING THE NOTICE OF INTENT AND STORM WATER POLLUTION PREVENTION PLAN (SWPPP) IN ACCORDANCE WITH STATE RULES AND REGULATIONS.
- CONTRACTOR SHALL OBTAIN AND MAINTAIN SWPPP THROUGHOUT THE ENTIRE DURATION OF CONSTRUCTION AND SURFACE IS RESTORED.
- 59. GRAVEL FILTER BAGS TO BE USED ALONG THE CURB WITHIN CONSTRUCTION LIMITS.

AS-BUILT / PLAN OF RECORD DATE OF COMPLETION: 03-19-2019 CONTRACTOR: S.J LOUIS CONSTRUCTION OF TEXAS, LTD. INSPECTOR: RICHARD KER SAWS JOB NO: <u>13-2506</u>

REVISED TO REFLECT CONSTRUCTION RECORDS

THIS RECORD DRAWING SET IS BASED UPON INFORMATION PROVIDED TO KIMLEY-HORN AND ASSOCIATES, INC. (TEXAS REGISTERED FIRM NO. F-928) BY SAWS' PROJECT INSPECTOR AND THE CONTRACTOR, INFORMATION PROVIDED REFLECTS THE CHANGES DURING CONSTRUCTION TO THE PLAN SET USED FOR BIDDING ORIGINALLY SEALED BY JEFFREY A. FARNSWORTH, P.E. NO. 80190

RECURU DIFAMING
HIS CONSTRUCTION OF THE CONTROLLENT WAS
PREPARED USING INFORMATION
SUPPILED BY THE CONTRACTOR TO
REPRESENT CONSTRUCTION CHANGES,
HIS DOCUMENT IS FOR INFORMATION
HIS OWNER'S USE AND COCUPANCY OF
THE PROJECT AND IS NOT INTENDED
FOR BID, PERMIT, OR CONSTRUCTION.

DATE: 03-19-2019

Kimley Horn

601 NW Loop 410 Suite 350

Tel No. 210-541-916 San Antonio, TX 78216 Fax No. 210-541-8699

No.	Revision	Ву	Date



DATE:

C-12 DONALDSON TERRACE PROJECT

SHEET

GENERAL NOTES (SHEET 2 OF 2)

DATE: MARCH 2019	SAWS PROJECT NO.	SHEET NO.
DESIGN: JAF	13-2506	
DRAWN: ABC	KHA PROJECT NO.	G3
CHECKED: VRS	068665011	

ESTIMATED QUANTITIES				
ITEM	DESCRIPTION	UNIT	QUANTITY	
100.1	MOBILIZATION	LS	1	
100.2	INTERMEDIATE DEMOBILIZATION/REMOBILIZATION	EA	1	
101.1	PREPARING RIGHT OF WAY		1	
103.1	REMOVE CONCRETE CURB		928	
103.3	REMOVE SIDEWALKS AND DRIVEWAYS	SF	2228	
202	PRIME COAT	GAL	1672	
203	TACK COAT	GAL	839	
205	HOT MIX ASPHALTIC PAVEMENT (3" THICK) (TYPE D)	SY	2084	
208	SALVAGING, HAULING, & STOCKPILING RECLAIMED ASPHALTIC PAVEMENT (3" THICK)	SY	2084	
239	MICRO-SURFACING	SY	23632	
500.4	CONCRETE CURB & GUTTER	LF	928	
502.1	CONCRETE SIDEWALK — CONVENTIONALLY FORMED	SF	380	
507	CHAINLINK FENCE	LF	567	
511.3	REPLACEMENT PAVEMENT - 10" ATB WITH 2" HMAC (TYPE D)	SY	5949	
	REPLACEMENT PAVEMENT - 10" ATB WITH 3" HMAC (TYPE D)	SY		
511.3			851	
515.1	TOPSOIL (4")	CY	51	
516	SODDING	SY	2267	
530	BARRICADE/SIGN/TRAFFIC HANDLING	LS	1	
535.1	4-INCH WDE YELLOW LINE	LF	4940	
535.2	4-INCH WIDE WHITE LINE	LF	3141	
535.7	24-INCH WIDE WHITE LINE	LF	75	
535.13	STRAIGHT WHITE ARROW	EA	4	
535.17	BICYCLE RIDER SYMBOL	EA	4	
540	EROSION/SEDIMENTATION CONTROL	LS	1	
540.9	TEMPORARY SEDIMENT CONTROL FENCE	LF	500	
550.1	TRENCH EXCAVATION SAFETY PROTECTION	LF	9711	
666 2003	REFLECTIVE PAVEMENT MARKET TYPE I (WIDTH) 4 INCH (DOT)(100MIL)	LF	1040	
848	8" SDR-26 (ASTM D-2241) PVC SANITARY SEWER LINE (6'-10')	LF	167	
848	8" SDR-26 (ASTM D-2241) PVC SANITARY SEWER LINE (10'-14')	LF	658	
848	24" FRP (ASTM D-3262) (PS-72) SANITARY SEWER LINE (6' - 10')	LF	559	
848	24" FRP (ASTM D-3262) (PS-72) SANITARY SEWER LINE (10' - 14')	LF	1931	
848	24" FRP (ASTM D-3262) (PS-72) SANITARY SEWER LINE (10 - 14)	LF	141	
	24" FRP (ASTM D-3262) (PS-72) SANITARY SEWER LINE (22" - 23")	<u> </u>		
848	1 1 1 1 1 1 1 1 1 1 1 1 1 1 1 1 1 1 1 1	LF	46	
848	24" FRP (ASTM D-3754) (PS-72) SANITARY SEWER LINE (10' - 14')	LF	545	
848	30" FRP (ASTM D-3262) (PS-72) SANITARY SEWER LINE (10' - 14')	LF	533	
848	30" FRP (ASTM D-3262) (PS-72) SANITARY SEWER LINE (14' - 18')	LF	308	
848	30" FRP (ASTM D-3262) (PS-72) SANITARY SEWER LINE (18' - 22')	LF	968	
848	30" FRP (ASTM D-3262) (PS-72) SANITARY SEWER LINE (22' - 25')	LF	525	
848	30" FRP (ASTM D-3262) (PS-72) SANITARY SEWER LINE (25' - 30')	LF	1557	
848	30" FRP (ASTM D-3754) (PS-72) SANITARY SEWER LINE (10' - 14')	LF	52	
848	30" FRP (ASTM D-3754) (PS-72) SANITARY SEWER LINE (14' - 18')	LF	291	
848	30" FRP (ASTM D-3754) (PS-72) SANITARY SEWER LINE (18' - 22')	LF	948	
848	30" FRP (ASTM D-3754) (PS-72) SANITARY SEWER LINE (22' - 25')	LF	418	
848	30" FRP (ASTM D-3754) (PS-72) SANITARY SEWER LINE (25' - 30')	LF	121	
852	STD. SANITARY SEWER MANHOLE (0'-6') (4' DIA.)	EA	3	
852	STD. SANITARY SEWER MANHOLE (EXTRA DEPTH)	EA	6	
853	SANITARY SEWER FRP MANHOLE (0'-6' DEPTH) (4' DIA.)	EA	13	
853	SANITARY SEWER FRP DROP MANHOLE (0'-6' DEPTH) (4' DIA.)	EA	1	
853	SANITARY SEWER FRP MANHOLE (0'-6' DEPTH) (6' DIA.)	EA	21	
853	SANITARY SEWER DROP FRP MANHOLE (0'-6' DEPTH) (6' DIA.)	EA	7	
853	SANITARY SEWER DROP FRP MANHOLE (CATRA DEPTH)	VF	542	
		<u> </u>		
854	SANITARY SEWER LATERALS	LF 54	50	
854	SANITARY SEWER TWO-WAY CLEANOUTS	EA	2	
856.1	JACKING, BORING, OR TUNNELING 42"	LF	40	
856.1	JACKING, BORING, OR TUNNELING 48"	LF	498	
856.2	24" CARRIER PIPE (SANITARY SEWER)	LF	40	
856.2	30" CARRIER PIPE (SANITARY SEWER)	LF	498	
856.3	42" STEEL CASING	LF	40	
		LF	1	

	ESTIMATED QUANTITIES			
ITEM	DESCRIPTION	UNIT	QUANTITY	
858	CONCRETE ENCASEMENT, CRADLES, SADDLES, AND COLLARS	CY	13	
862	ABANDONMENT OF 18" SANITARY SEWER LINE	LF	4253	
862	ABANDONMENT OF 21" SANITARY SEWER LINE	LF	172	
864	BYPASS PUMPING	LS	1	
866	SANITARY SEWER POST TELEVISION INSPECTION (8"-15")	LF	763	
866	SANITARY SEWER POST TELEVISION INSPECTION (18"-24")	LF	3262	
866	SANITARY SEWER POST TELEVISION INSPECTION (30" AND LARGER)	LF	6219	
1020	WATER MAIN BREAKS/LEAK REPAIRS	EA	10	
3000	REMOVAL, TRANSPORTATION, AND DISPOSAL - AC PIPE	LF	100	

AS-BUILT / PLAN OF RECORD
DATE OF COMPLETION: 03-19-2019
CONTRACTOR: S.J LOUIS
CONSTRUCTION OF TEXAS, LTD.
INSPECTOR: RICHARD KER
SAWS JOB NO: 13-2506

REVISED TO REFLECT CONSTRUCTION RECORDS

THIS RECORD DRAWING SET IS BASED UPON INFORMATION
PROVIDED TO KIMLEY-HORN AND ASSOCIATES, INC. (TEXAS
REGISTERED FIRM NO. F-928) BY SAWS' PROJECT INSPECTOR AND
THE CONTRACTOR. INFORMATION PROVIDED REFLECTS THE
CHANGES DURING CONSTRUCTION TO THE PLAN SET USED FOR
BIDDING ORIGINALLY SEALED BY
JEFFREY A. FARNSWORTH, P.E. NO. 80190

THIS CONS PREPAR SUPPLIED REPRESENT THIS DOCU AND REFER THE OWNER' THE PROJE FOR BID, F	CORD DRAWING TRUCTION DOCUMENT WAS ED USING INFORMATION BY THE CONTRACTOR OF BY THE CONTRACTO		Tel No.	Orn 210-541-9166 210-541-8699
No.		Revision	Ву	Date
SAN ANTONIO WATER SYSTEM		C-12 DONAI TERRACE PR		
		<u>SHEET</u>		
		OVERA QUANTIT		

SAWS PROJECT NO.

13-2506

KHA PROJECT NO.

068665011


G4

DATE: MARCH 2019


DESIGN: JAF

DRAWN: ABC

CHECKED: VRS

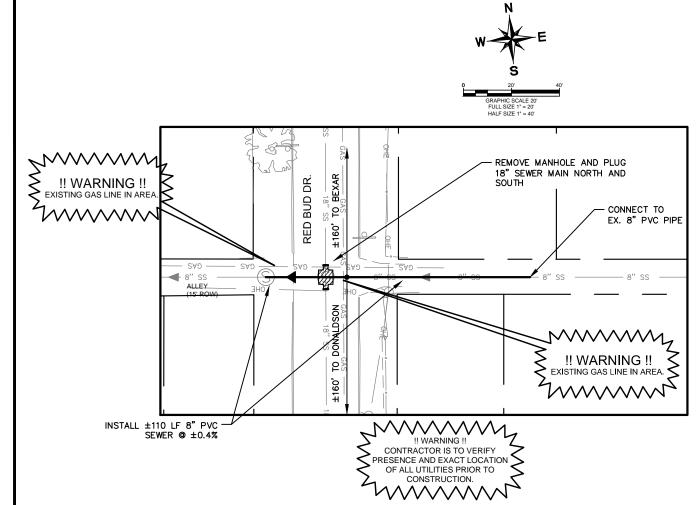

1. SEE REMOVAL AND ABANDONMENT PLAN (SHEET 2 OF 3) FOR LOCATION OF TIE-IN

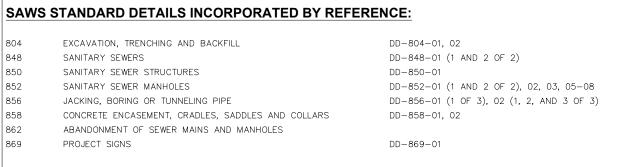

MODIFIED EXTERNAL DROP ASSEMBLY DETAIL

ŝ

90.0.

*CONTRACTOR TO VISIT SAWS WEBSITE (WWW.SAWS.ORG) FOR UPDATED DETAILS

- VARIES

2' MIN.'

PROPOSED SANITARY -

TURN BOTTOM 90° ELBOW PERPENDICULAR TO PROPOSED 30"

OUTFALL PIPE

SEWER MANHOLE TYPE

"B" WITH EXTERNAL DROP

EXTERNAL DROP PER SAWS DETAIL

DD-852-08 (1 OF 1)

AS-BUILT / PLAN OF RECORD DATE OF COMPLETION: 03-19-2019 CONTRACTOR: S.J LOUIS CONSTRUCTION OF TEXAS, LTD. INSPECTOR: RICHARD KER SAWS JOB NO: 13-2506

- EXISTING GROUND PROPOSED SANITARY SEWER LINE

Kimley » Horn

DATE: 03-19-2019

601 NW Loop 410 Suite 350 Tel No. 210-541-9166

No. Revision By Date C-12 DONALDSON

REVISED TO REFLECT CONSTRUCTION RECORDS

THIS RECORD DRAWING SET IS BASED UPON INFORMATION

PROVIDED TO KIMLEY-HORN AND ASSOCIATES, INC. (TEXAS

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THE CONTRACTOR, INFORMATION PROVIDED REFLECTS THE

CHANGES DURING CONSTRUCTION TO THE PLAN SET USED FOR

BIDDING ORIGINALLY SEALED BY JEFFREY A. FARNSWORTH, P.E. NO. 80190

IF INCOMING LATERAL PIPE IS LESS THAN 90° TO DOWNSTREAM PIPE, TURN BOTTOM 90°

ELBOW PERPENDICULAR

TO PROPOSED 30"

- MANHOLE RISER

OUTFALL PIPE

SAN ANTONIO WATER SYSTEM ANTONIC

GENERAL DETAILS

TERRACE PROJECT

SHEET

DATE: MARCH 2019 SAWS PROJECT NO. DESIGN: JAF 13-2506 G5 DRAWN: ABC KHA PROJECT NO. CHECKED: VRS 068665011

1+00.0 ET TO E MANHOL = 711.2 = 711.1 750 750 토르片 740 740 730 730 720 720 710 710 NSTALL 110.00 L.F. 8" SDR-26 (ASTM D-2241) PVC EXIST. 8" PVC-@ 0.40% (MATCH EXISTING SLOPE) 8" PVC-700 700 690 690 1+00 1+50 2+00

*NOTE: SEPARATION DISTANCE TO COMPLY WITH 30 TAC 217.53 SEWER-WATER CROSSING DETAIL (N.S.P.I.)

ASTM D-3754 PS 72 FRP BELOW ALL WATER AND WATER SERVICE CROSSINGS


AN 18' WASTEWATER LINE SEGMENT SHALL BE CENTERED ON EXISTING WATERLINE CROSSING AND EMBEDDED IN CEMENT STABILIZED SAND FOR THE TOTAL LENGTH OF ONE PIPE SEGMENT PLUS 12 INCHES


BEYOND THE JOINT ON EACH END


EXISTING WATER LINE


8" SEWER EXTENSION PLAN AND PROFILE


SCALE: 1" = 40' HORIZ 1" = 20' VERT

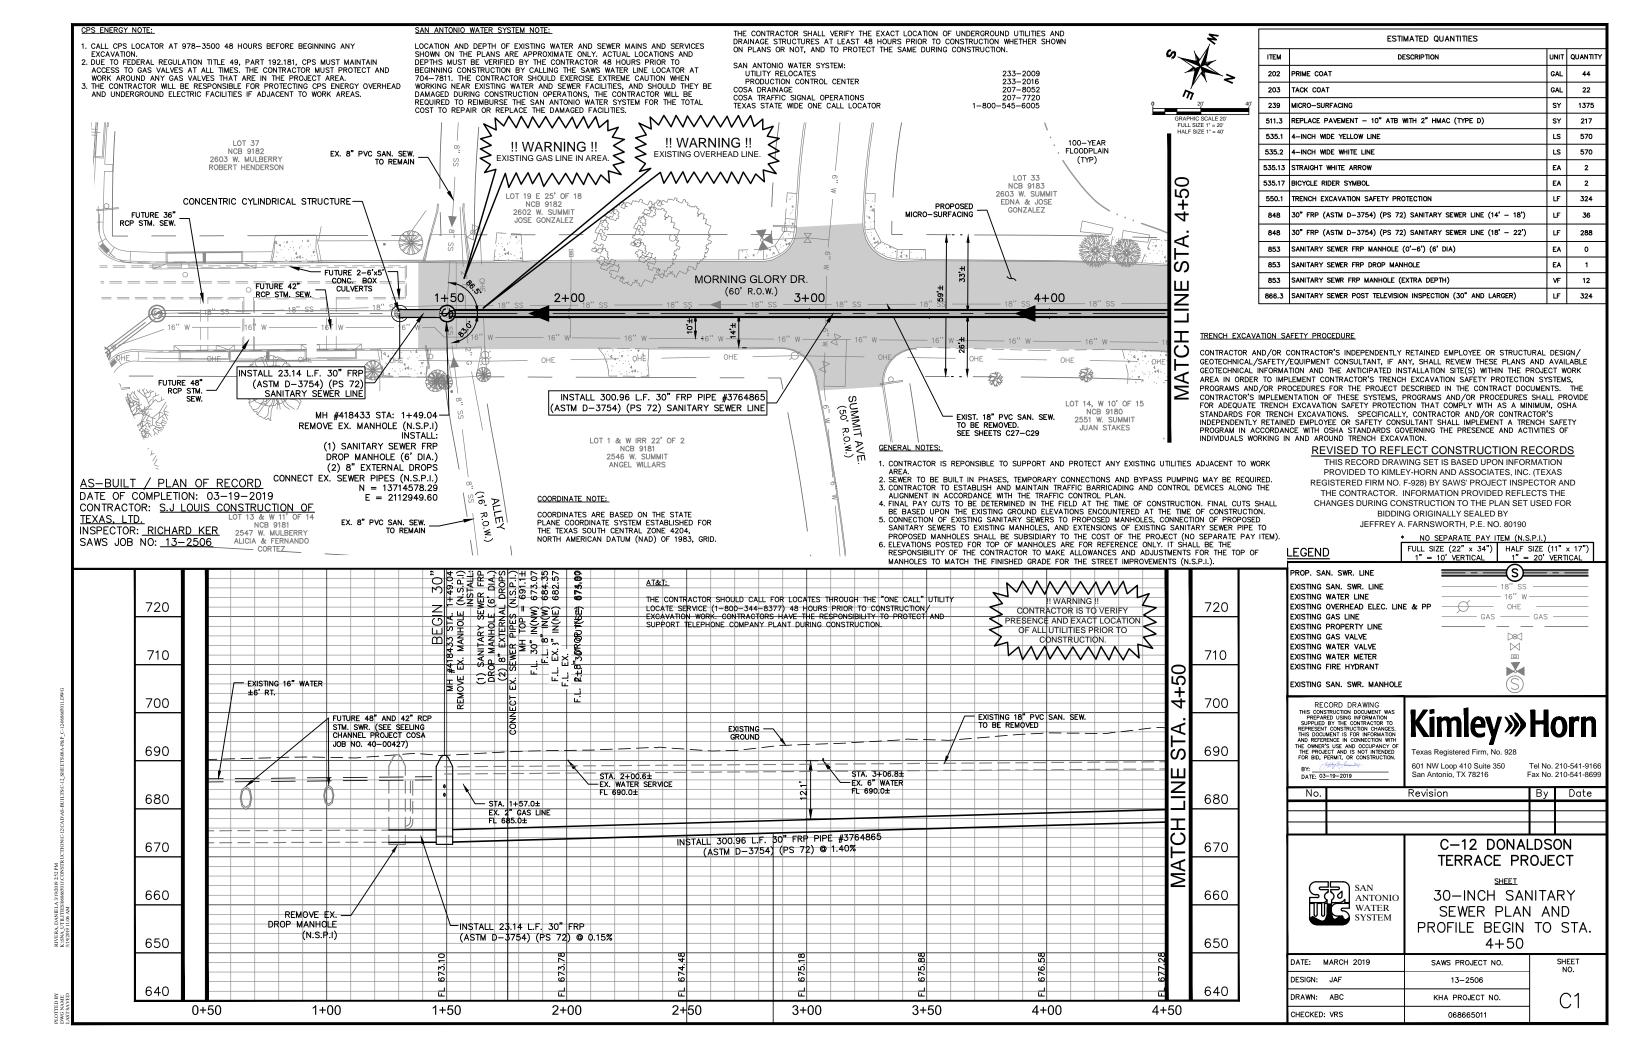


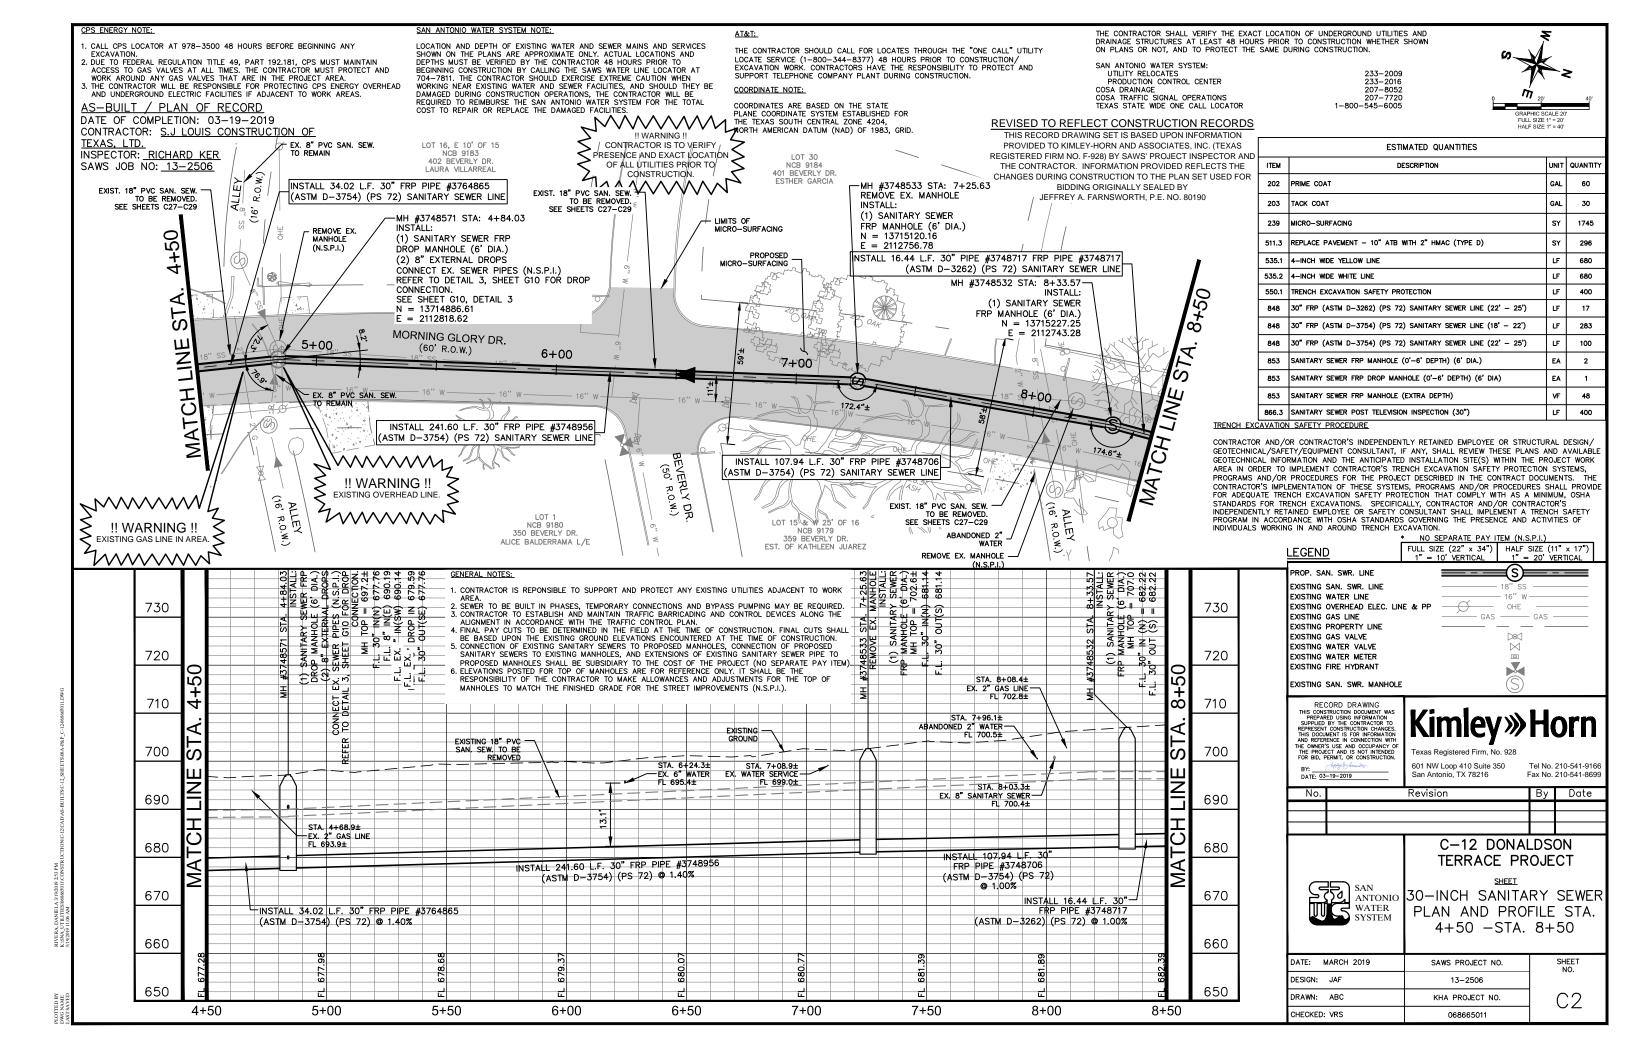


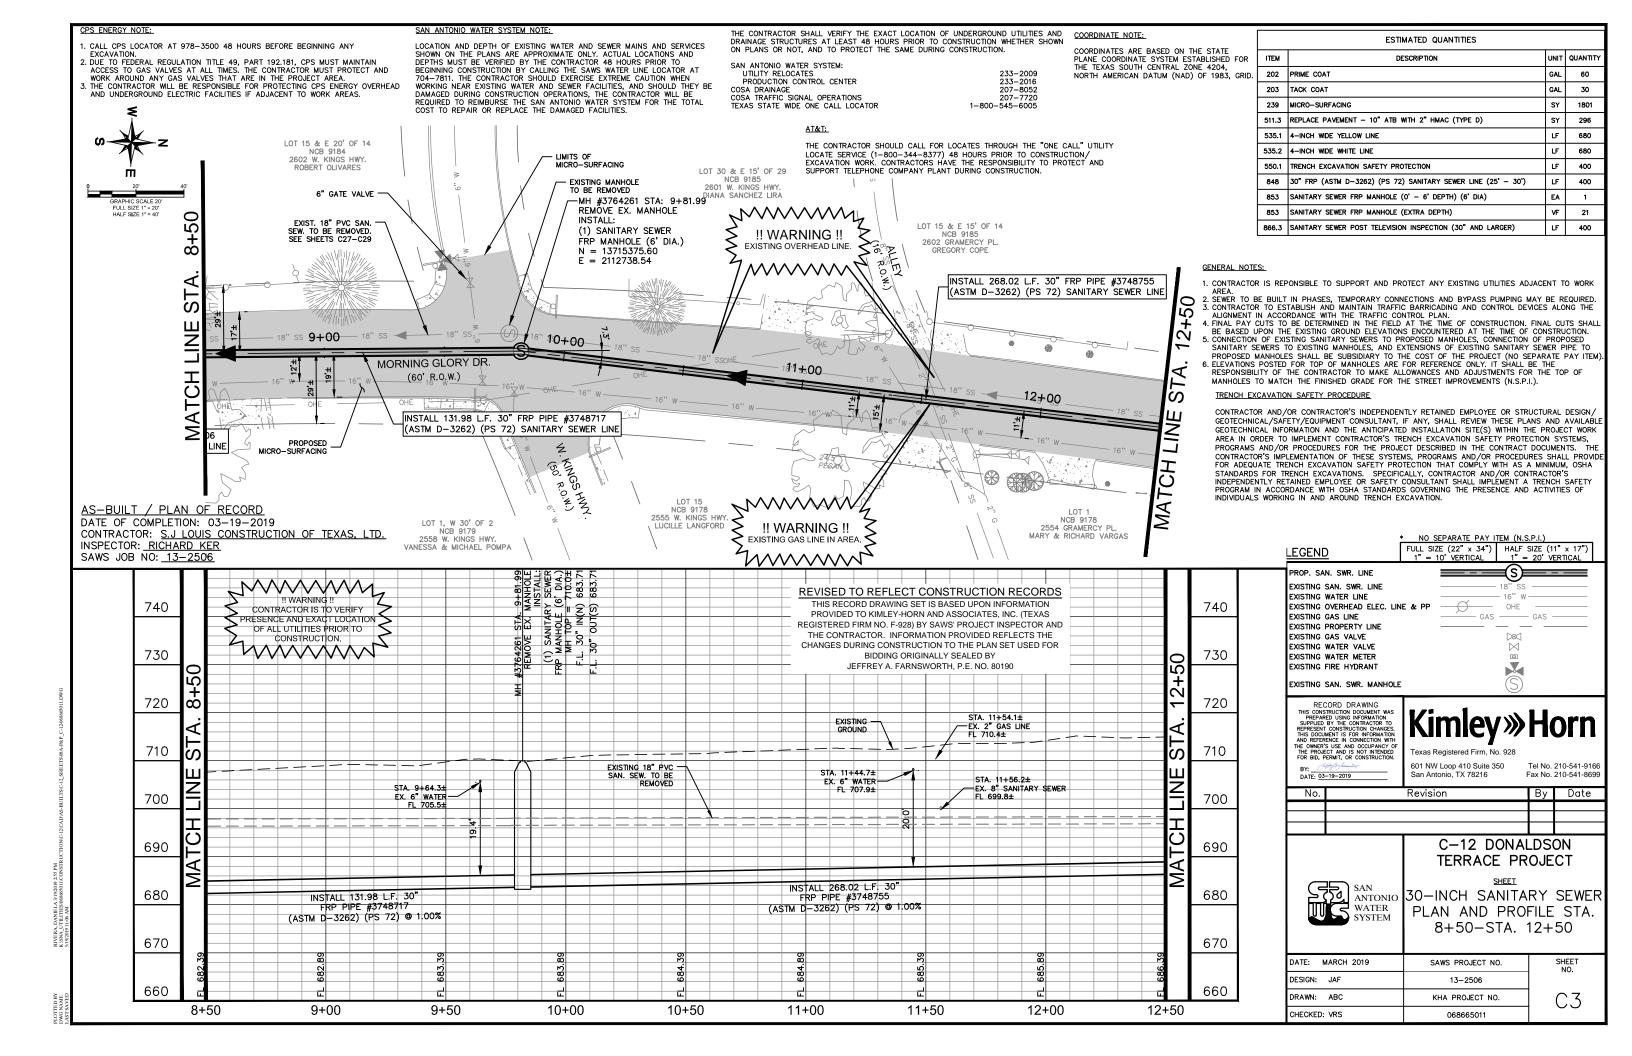

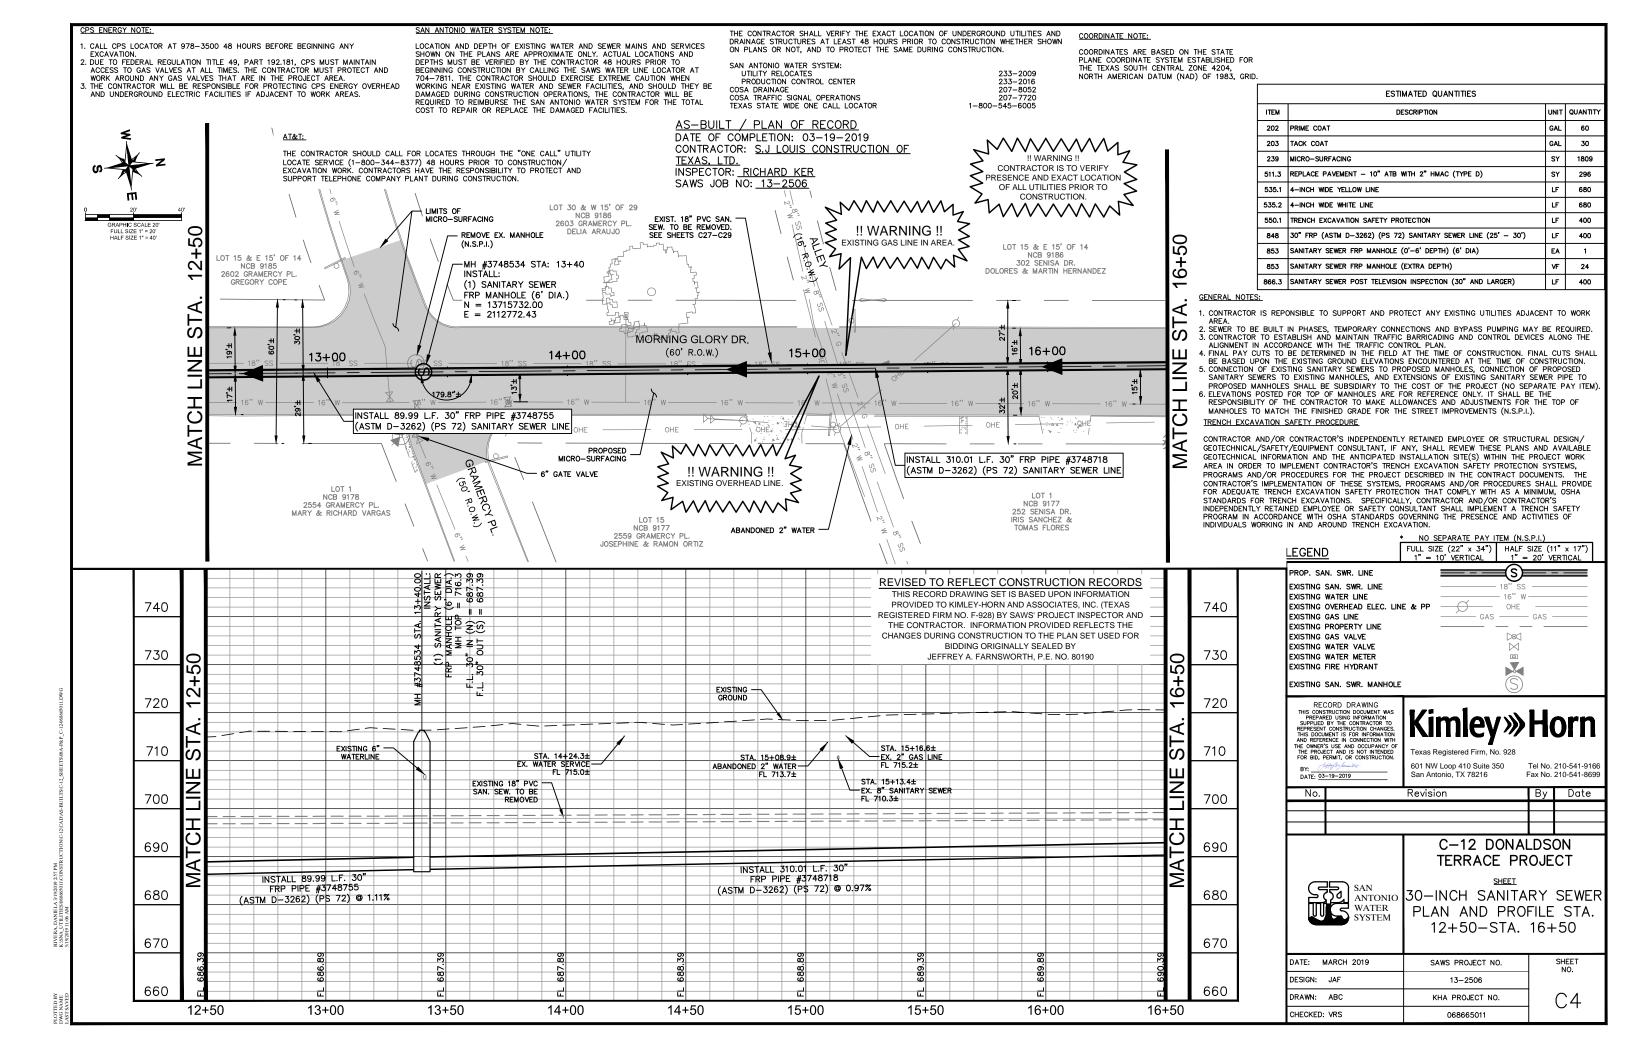

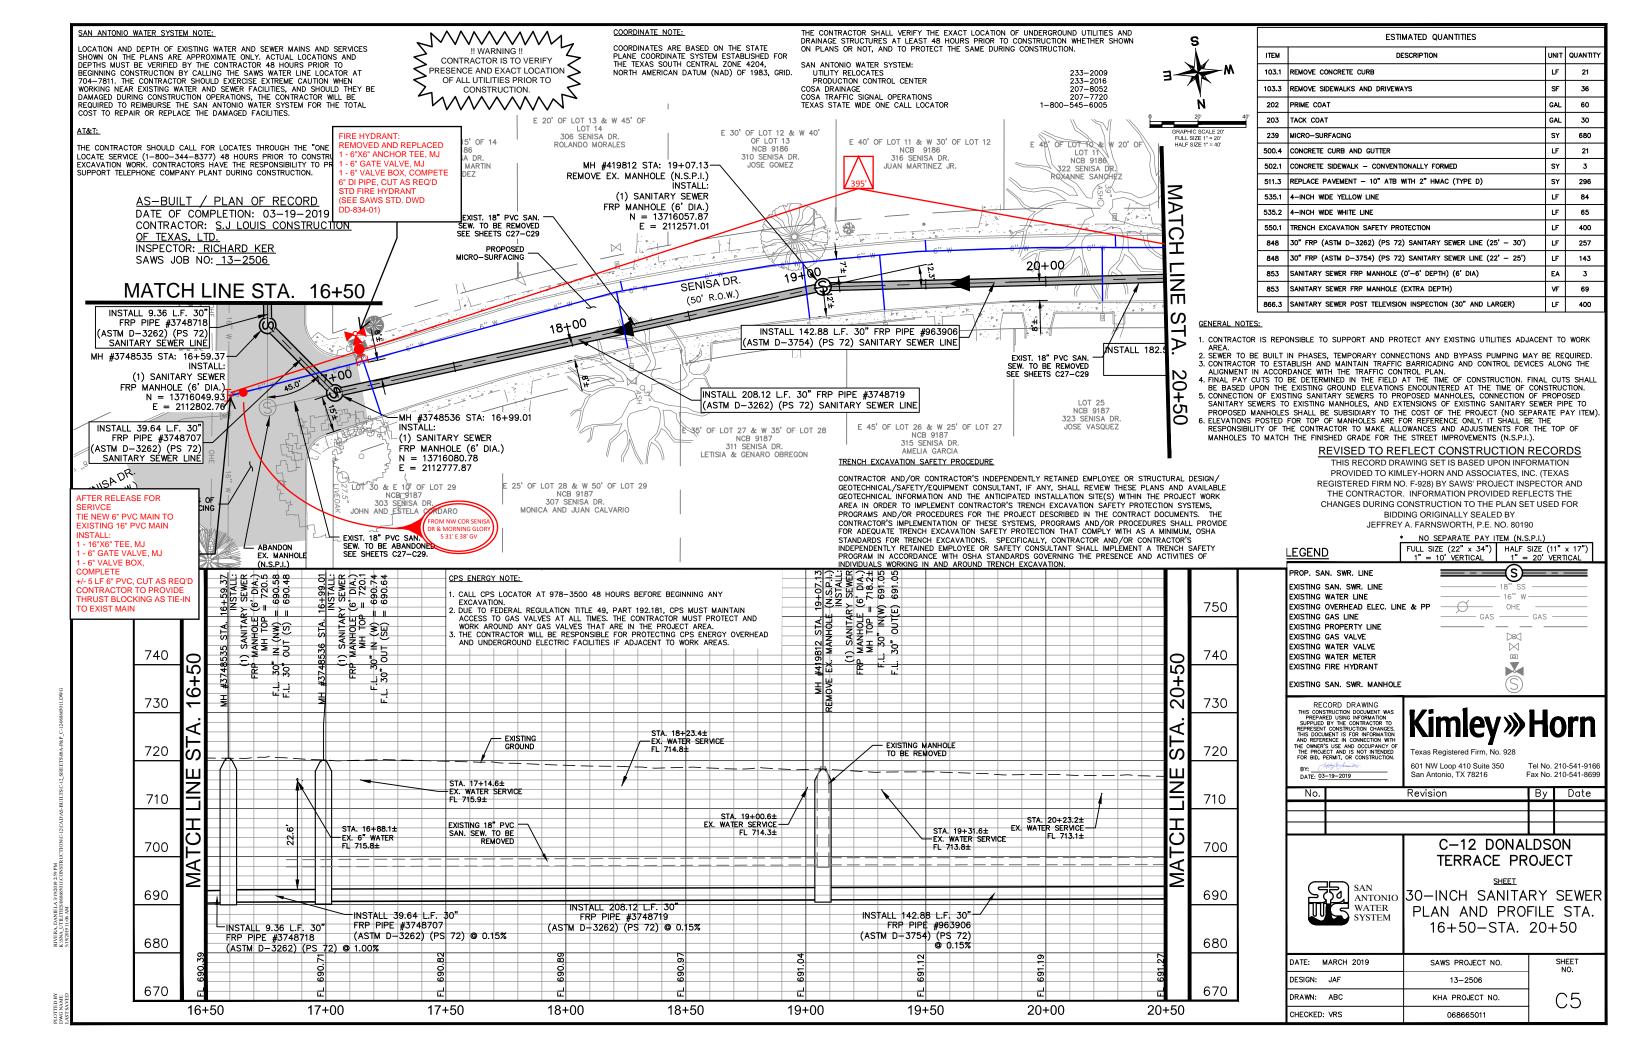

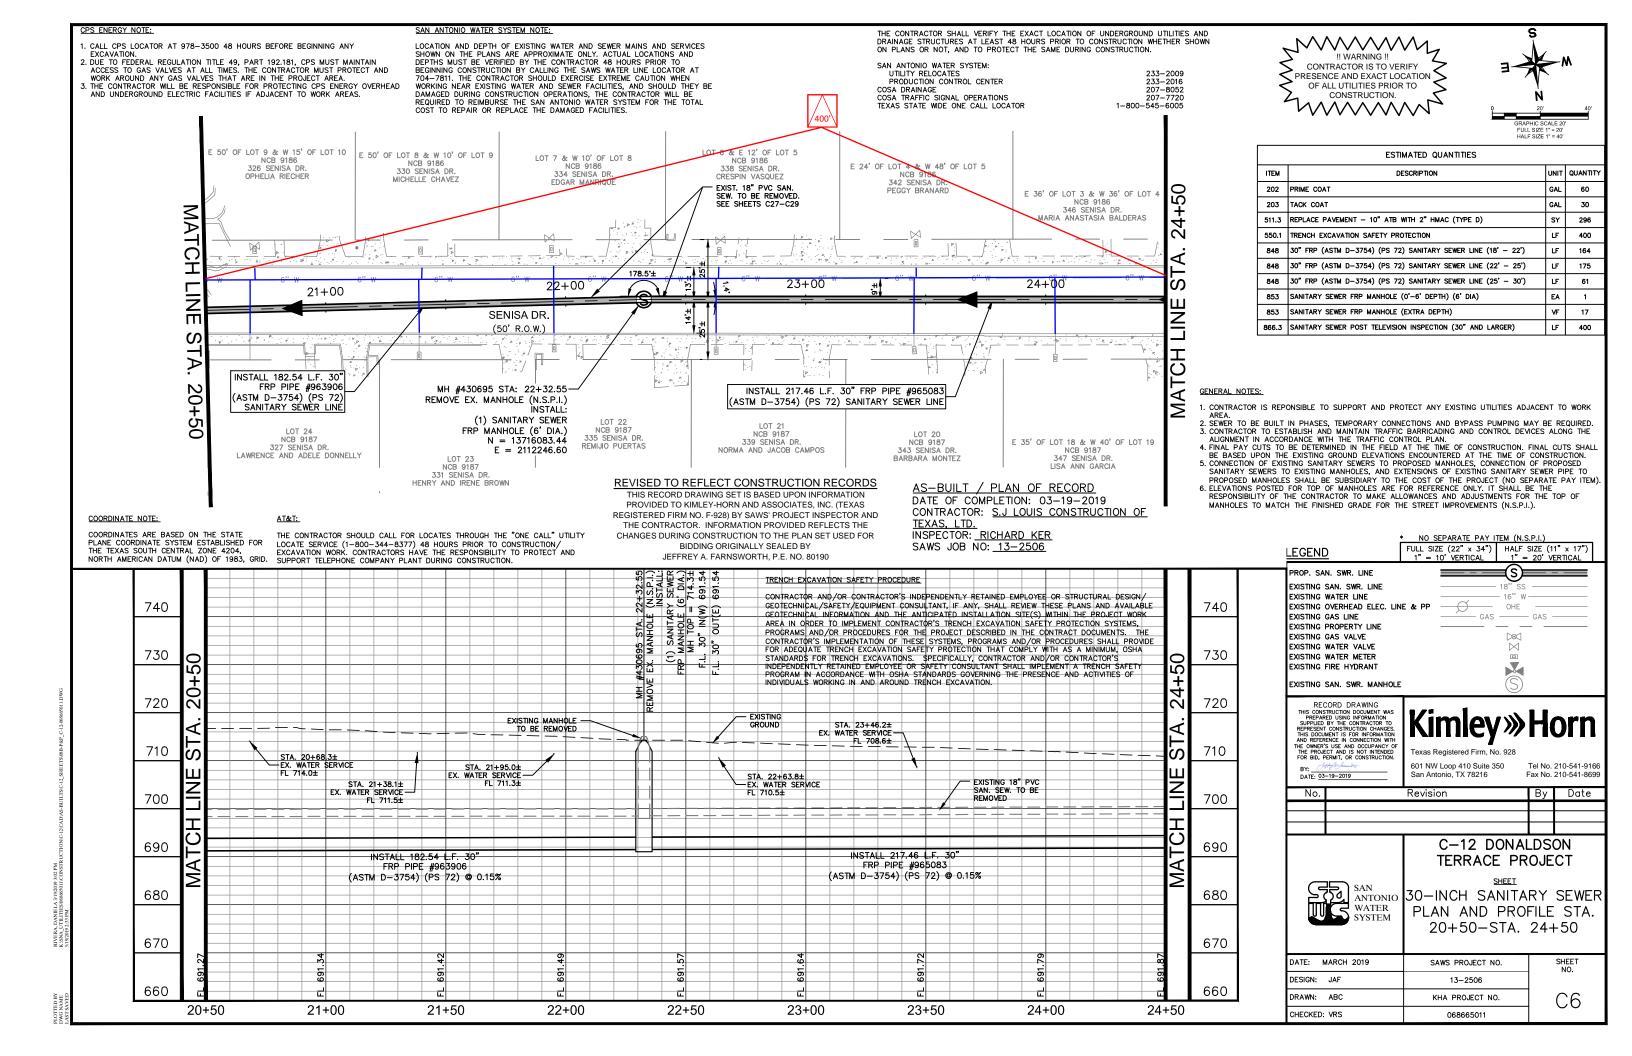

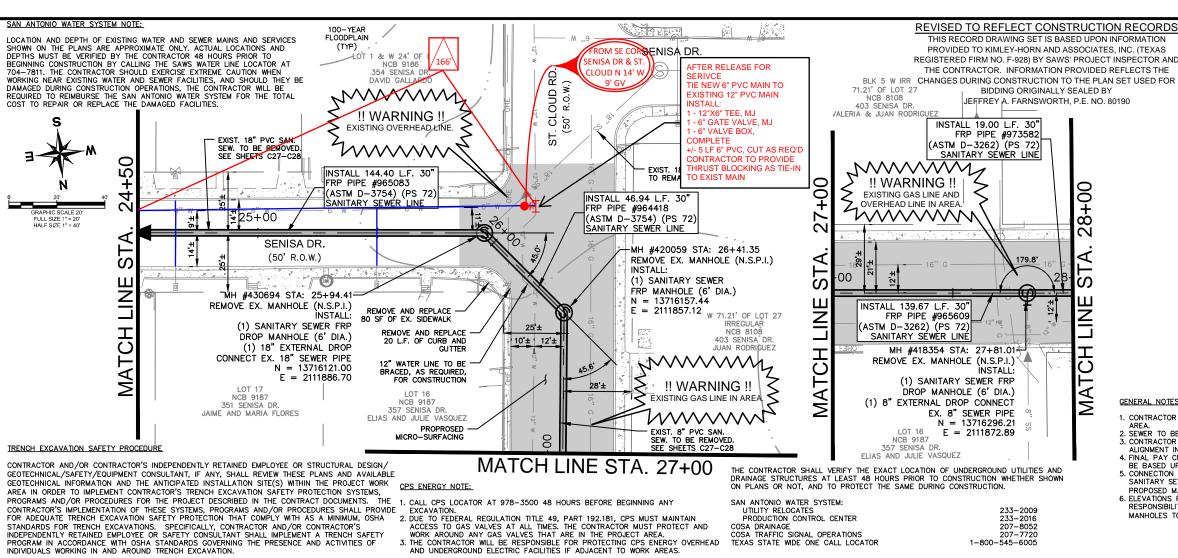

ESTIMATED QUANTITIES UNIT QUANTIT DESCRIPTION ITEM 103.1 REMOVE CONCRETE CURE LF 20 103.3 REMOVE SIDEWALKS AND DRIVEWAYS SY 80 202 PRIME COAT GAL 52 203 TACK COAT GAL 26 MICRO-SURFACING SY 1125 LF 20 500.4 CONCRETE CURB AND GUTTER 502.1 CONCRETE SIDEWALK - CONVENTIONALLY FORMED SY 9 511.3 REPLACEMENT PAVEMENT - 10" ATB WITH 2" HMAC (TYPE D) SY 160 100 511.3 REPLACEMENT PAVEMENT - 10" ATB WITH 3" HMAC (TYPE D) SY LF 180 535.1 4-INCH WIDE YELLOW LINE LF REFLECTIVE PAVEMENT MARKER TYPE 1 4" WIDTH (DOT)(100MIL) 210 TRENCH EXCAVATION SAFETY PROTECTION LF 350 550.1 848 30" FRP (ASTM D-3262) (PS 72) SANITARY SEWER LINE (14' - 18') 17 LF 123 848 30" FRP (ASTM D-3262) (PS 72) SANITARY SEWER LINE (18' - 22') LF 848 30" FRP (ASTM D-3754) (PS 72) SANITARY SEWER LINE (14' - 18') LF 158 52 848 30" FRP (ASTM D-3754) (PS 72) SANITARY SEWER LINE (18' - 22') LF SANITARY SEWER FRP MANHOLE (0'-6' DEPTH) (6' DIA) EΑ 853 SANITARY SEWER FRP DROP MANHOLE (0'-6' DEPTH) (6' DIA) EA 2 853 SANITARY SEWER FRP MANHOLE (EXTRA DEPTH) VF | 36 866.3 SANITARY SEWER POST TELEVISION INSPECTION (30" AND LARGER) LF 350

GENERAL NOTES:

- 1. CONTRACTOR IS REPONSIBLE TO SUPPORT AND PROTECT ANY EXISTING UTILITIES ADJACENT TO WORK
- AREA.

 2. SEWER TO BE BUILT IN PHASES, TEMPORARY CONNECTIONS AND BYPASS PUMPING MAY BE REQUIRED.

 3. CONTRACTOR TO ESTABLISH AND MAINTAIN TRAFFIC BARRICADING AND CONTROL DEVICES ALONG THE ALICNMENT IN ACCORDANCE WITH THE TRAFFIC CONTROL PLAN.

 4. FINAL PAY CUTS TO BE DETERMINED IN THE FIELD AT THE TIME OF CONSTRUCTION. FINAL CUTS SHALL BE BASED UPON THE EXISTING GROUND ELEVATIONS ENCOUNTERED AT THE TIME OF CONSTRUCTION.

 5. CONNECTION OF EXISTING SANITARY SEWERS TO PROPOSED MANHOLES, CONNECTION OF PROPOSED. SANITARY SEWERS TO EXISTING MANHOLES. AND EXTENSIONS OF EXISTING SANITARY SEWER PIPE TO
- PROPOSED MANHOLES SHALL BE SUBSIDIARY TO THE COST OF EASING SANITACT SETTEMPT TO PROPOSED MANHOLES SHALL BE SUBSIDIARY TO THE COST OF THE PROJECT (NO SEPARATE PAY ITEM).

 6. ELEVATIONS POSTED FOR TOP OF MANHOLES ARE FOR REFERENCE ONLY, IT SHALL BE THE RESPONSIBILITY OF THE CONTRACTOR TO MAKE ALLOWANCES AND ADJUSTMENTS FOR THE TOP OF MANHOLES TO MATCH THE FINISHED GRADE FOR THE STREET IMPROVEMENTS (N.S.P.I.).

3. THE CONTRACTOR WILL BE RESPONSIBLE FOR PROTECTING CPS ENERGY OVERHEAD AND UNDERGROUND ELECTRIC FACILITIES IF ADJACENT TO WORK AREAS. TEXAS STATE WIDE ONE CALL LOCATOR 1-800-545-6005 LEGEND COORDINATE NOTE: A. 25+94.

J.E. (N.S.P.)

SEWER FR

SEWER PIR

J.E. (6' DIA

SEWER PIR

SEWER AS-BUILT / PLAN OF MH #418354 STA. 27+81

OVE FX MANHOLE (N.S.P

(1) SANITARY SEWER F

DROP MANHOLE (G D)

EXTERNAL DROP CONNE

EX. 8" SEWER P

F.L. 50" NN (K) = 692

F.L. 8" DROP IN (E) = 705

F.L. 8" DROP IN (E) = 705

F.L. 8" DROP IN (E) = 705

F.L. 8" DROP IN (E) = 694. COORDINATES ARE BASED ON THE STATE **RECORD** PLANE COORDINATE SYSTEM ESTABLISHED FOR THE TEXAS SOUTH CENTRAL ZONE 4204, NORTH AMERICAN DATUM (NAD) OF 1983, GRID. 740 740 DATE OF COMPLETION: 03-19-2019 CONTRACTOR: S.J LOUIS CONSTRUCTION OF TEXAS Ed Si 730 730 <u>--</u>; X;-INSPECTOR: RICHARD KER HE CONTRACTOR SHOULD CALL FOR LOCATES THROUGH THE "DNE CALL" UTILIT Ó LOCATE SERVICE (1-800-344-8377) AS HOURS PRIOR TO CONSTRUCTION/ EXCAVATION WORK CONTRACTORS HAVE THE RESPONSIBILITY TO PROTECT AND SUPPORT TELEPHONE COMPANY PLANT DURING CONSTRUCTION. SAWS JOB NO: 13-2506 720 720 Ξ STA, 25+49.2± EX. WATER SERVICE FL 704.8± STA 24+64 9+ EXISTING 8" PVC SAN. EX. WATER SERVICE EXISTING SEW. TO BE REMOVED GROUND STA 27+68-3+ 710 710 EX, 2" GAS LINE-EXISTING MANHOLE TO BE REMOVED STA. 26+16.9+ FL 708.7± EXISTING MANHOLE EXISTING 18" PVC TO BE REMOVED Nο. _+=== 700 700 690 690 INSTALL 139.67 L.F. 30" FRP PIPE #965609 NSTALL 144 40 L.E. 30' FRP PIPF #965083 (ASTM D-3262) (PS 72) @ 0.15% (ASTM D-3754) (PS 72) @ 0.15% INSTALL 19.00 L.F. 30" INSTALL 46.94 L.F. 30" 680 680 FRP PIPE #973582 FRP PIPE #964418 (ASTM D-3262) (PS 72) @ 0.15% (ASTM D-3754) (PS 72) @ 0.15% 670 670 DESIGN: JAF 660 660 24+50 25+00 25+50 26+00 26+50 27+00 27+50 28+00

HALF SIZE (11" x 17") 1" = 20' VERTICAL FULL SIZE (22" x 34") ROP. SAN. SWR. LINE XISTING SAN SWR LINE EXISTING WATER LINE EXISTING OVERHEAD ELEC. LINE & PP OHE EXISTING GAS LINE EXISTING PROPERTY LINE XISTING GAS VALVE XISTING WATER VALVE XISTING WATER METER XISTING FIRE HYDRANT EXISTING SAN. SWR. MANHOLE RECORD DRAWING THIS CONSTRUCTION DOCUMENT WAS PREPARED USING INFORMATION SUPPLIED BY THE CONTRACTOR TO REPRESENT CONSTRUCTION CHANGES. THIS DOCUMENT IS FOR INFORMATION AND REFERENCE IN CONNECTION WITH EDWIRE SUE AND OCCUPANCY OF THE PROJECT AND IS NOT INTENDED. **Kimley** Whorn 601 NW Loop 410 Suite 350 Tel No. 210-541-916 DATF: 03-19-2019 Revision By Date C-12 DONALDSON


NO SEPARATE PAY ITEM (N.S.P.I.)


SAN ANTONIO WATER


TERRACE PROJECT SHEET


30-INCH SANITARY SEWER PLAN AND PROFILE STA 24+50-STA. 28+00


DATE: MARCH 2019 SHEET SAWS PROJECT NO. 13-2506 DRAWN: ABC KHA PROJECT NO. CHECKED: VRS 068665011

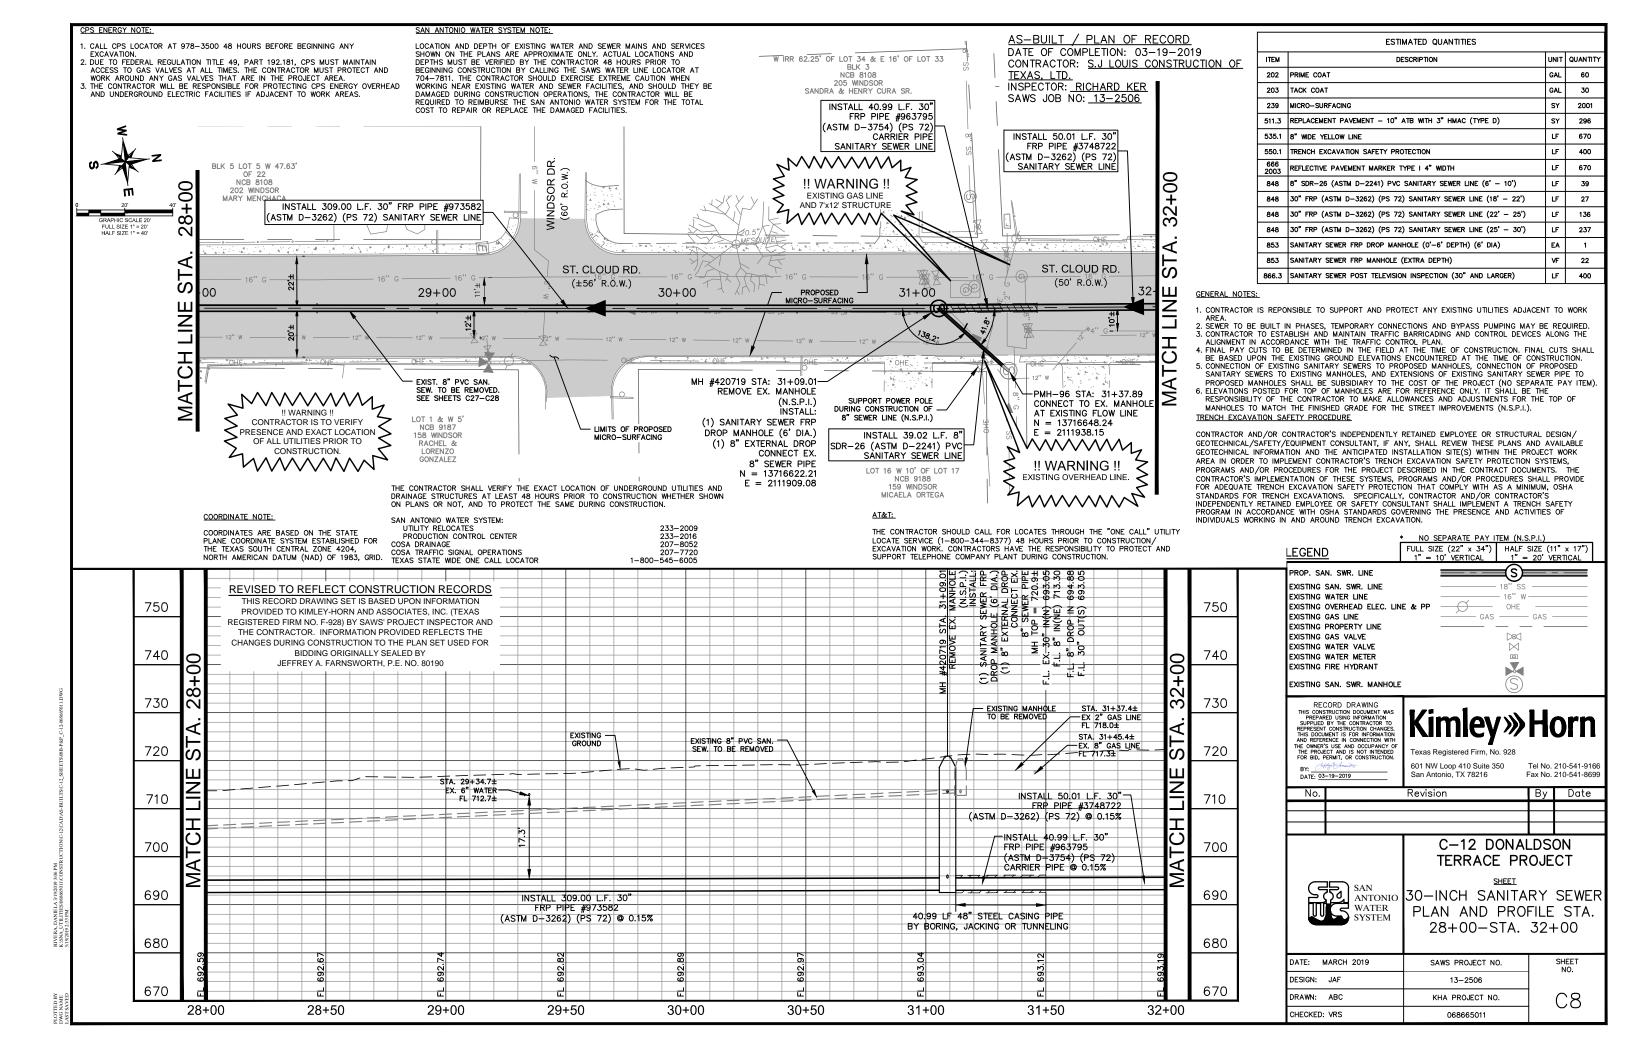


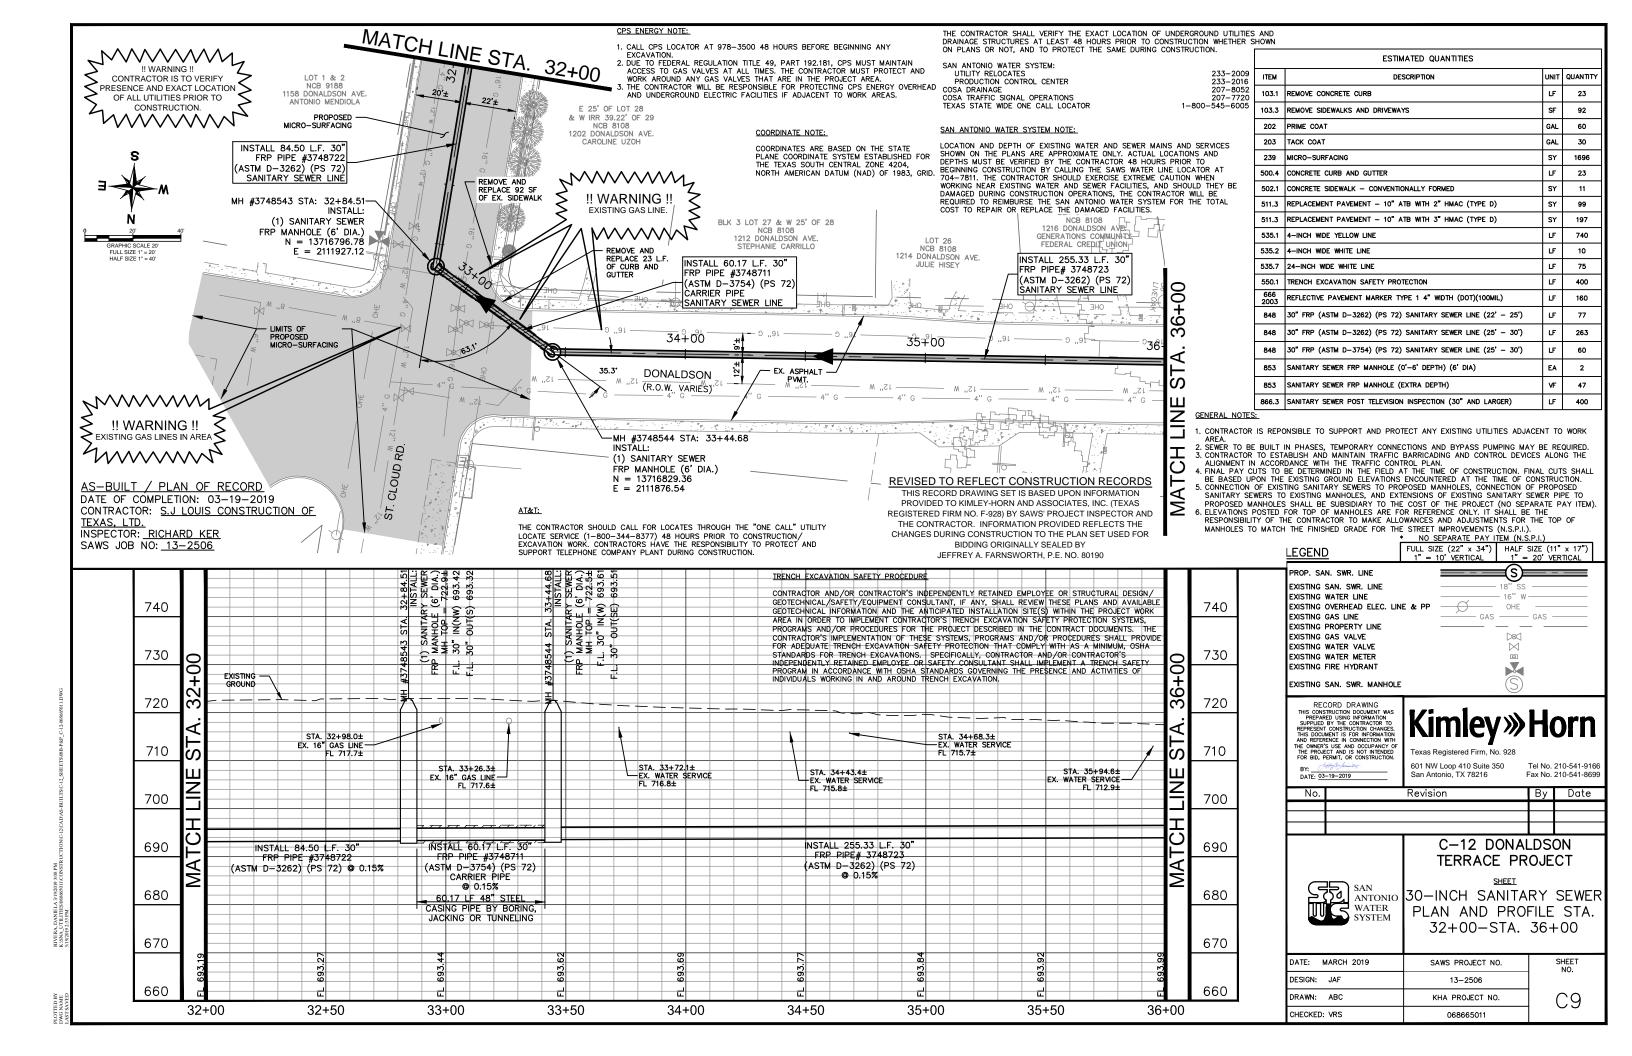


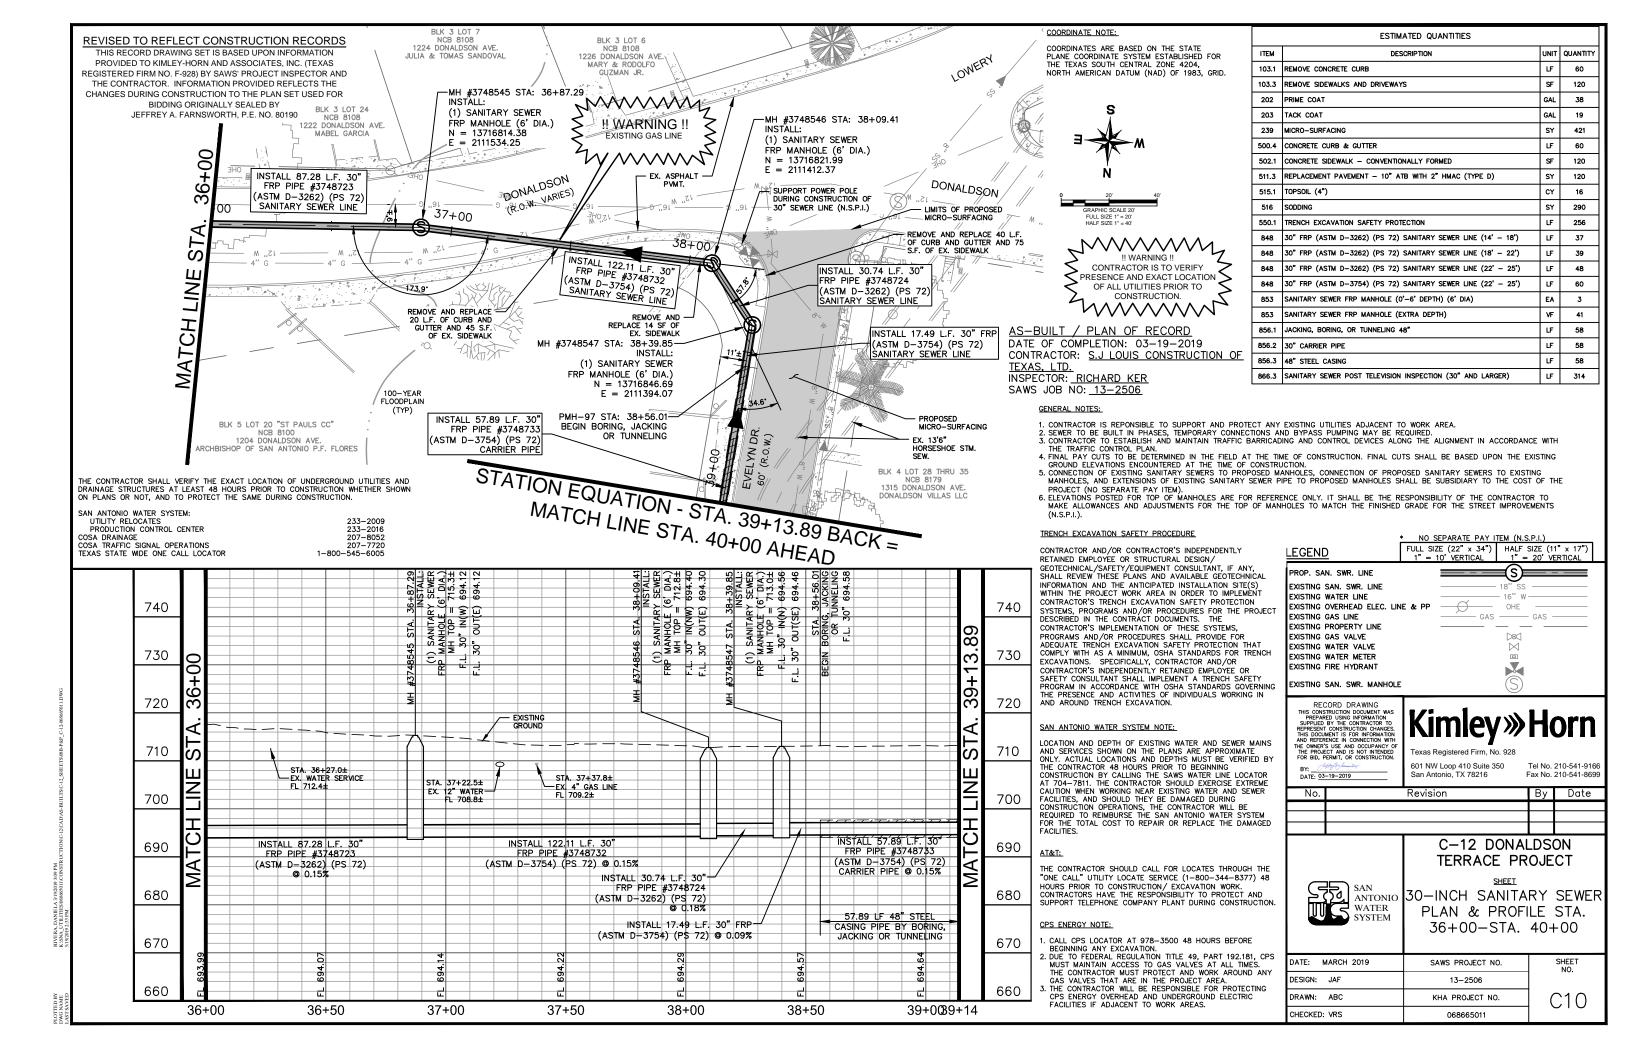


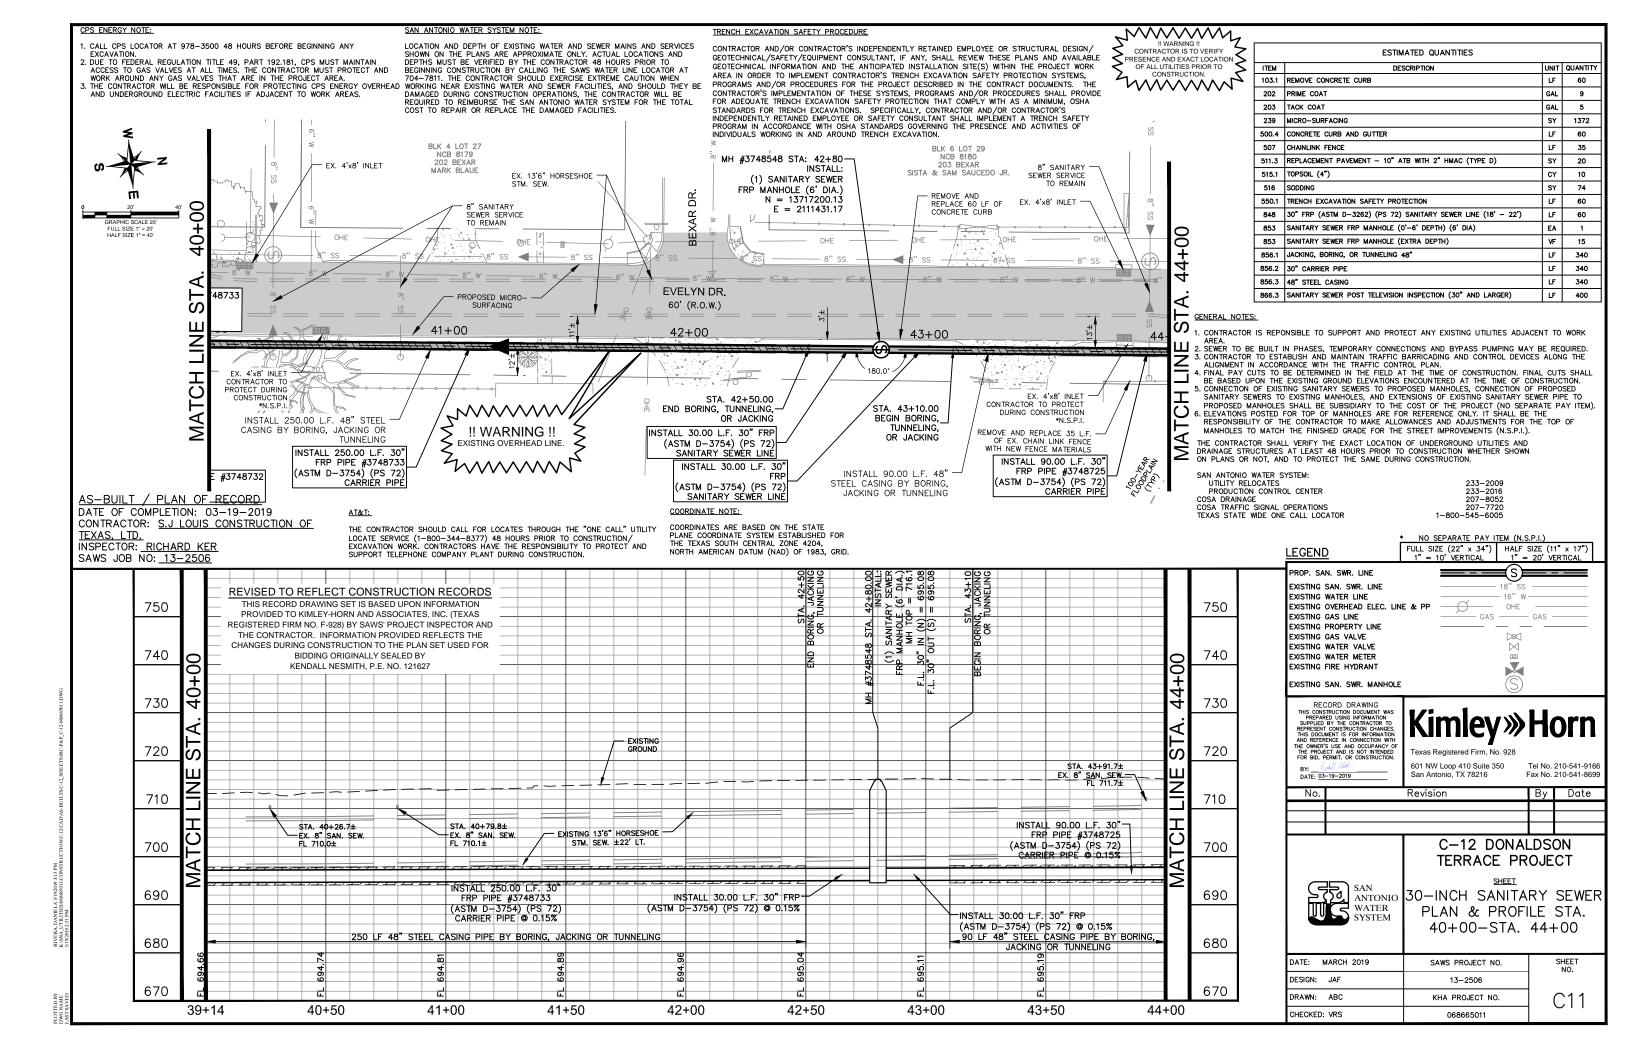


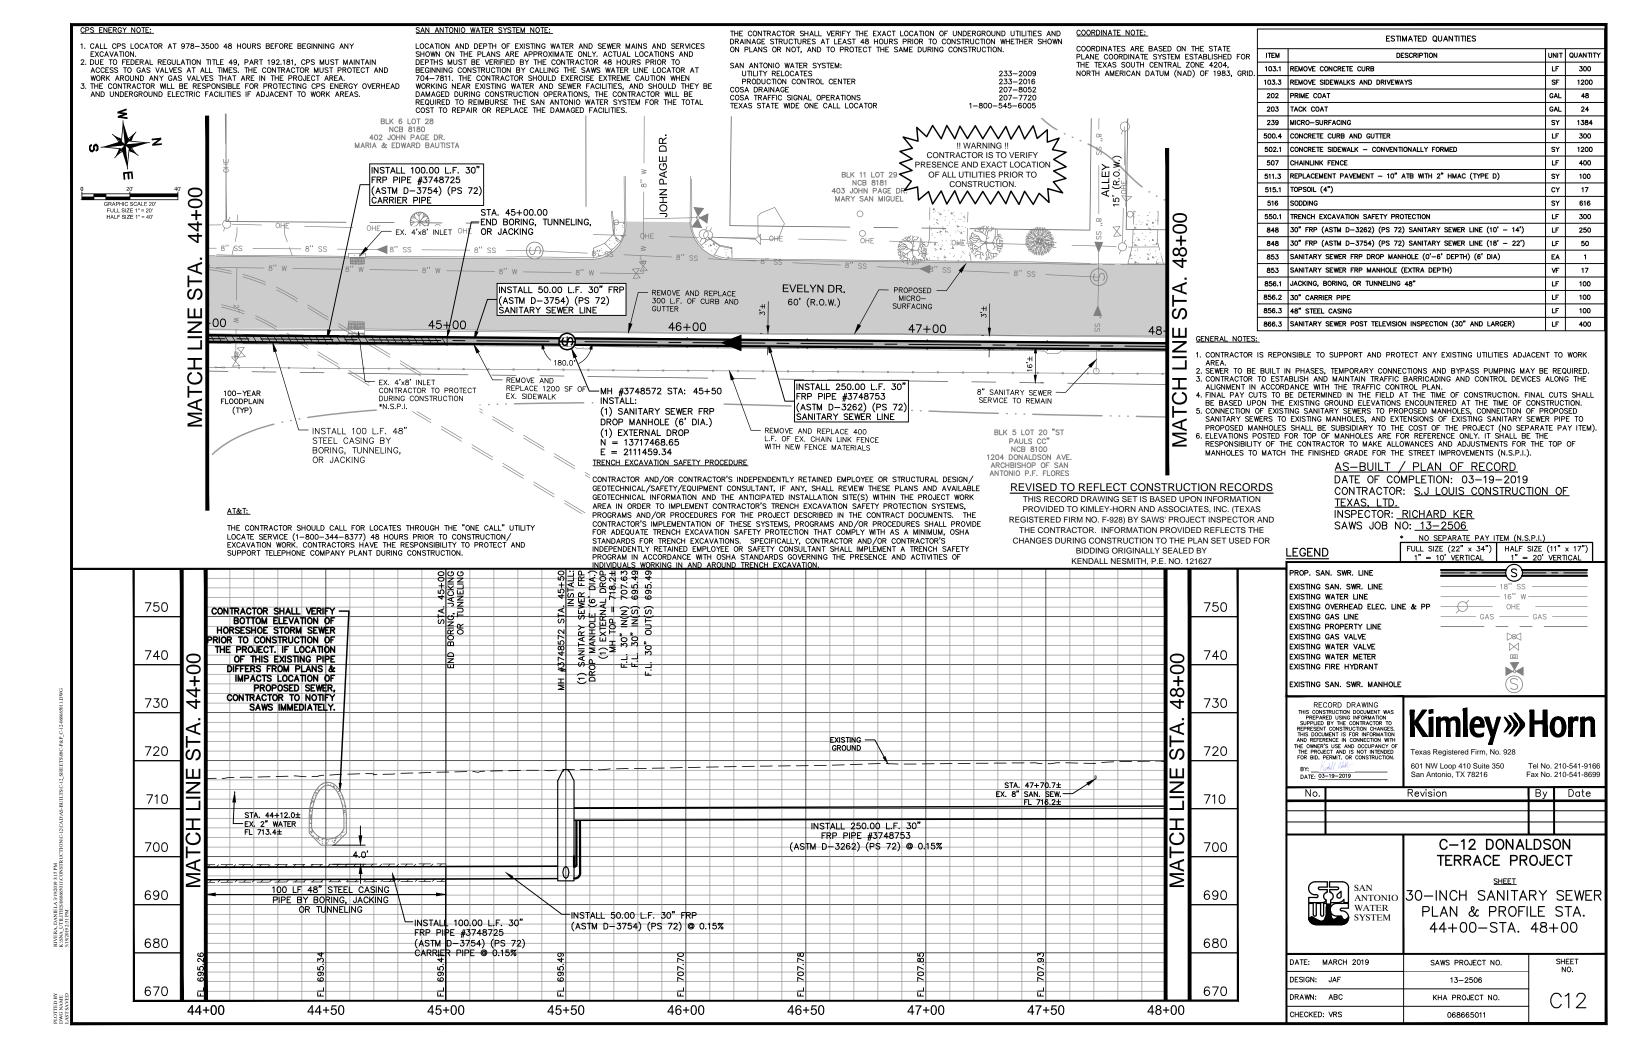


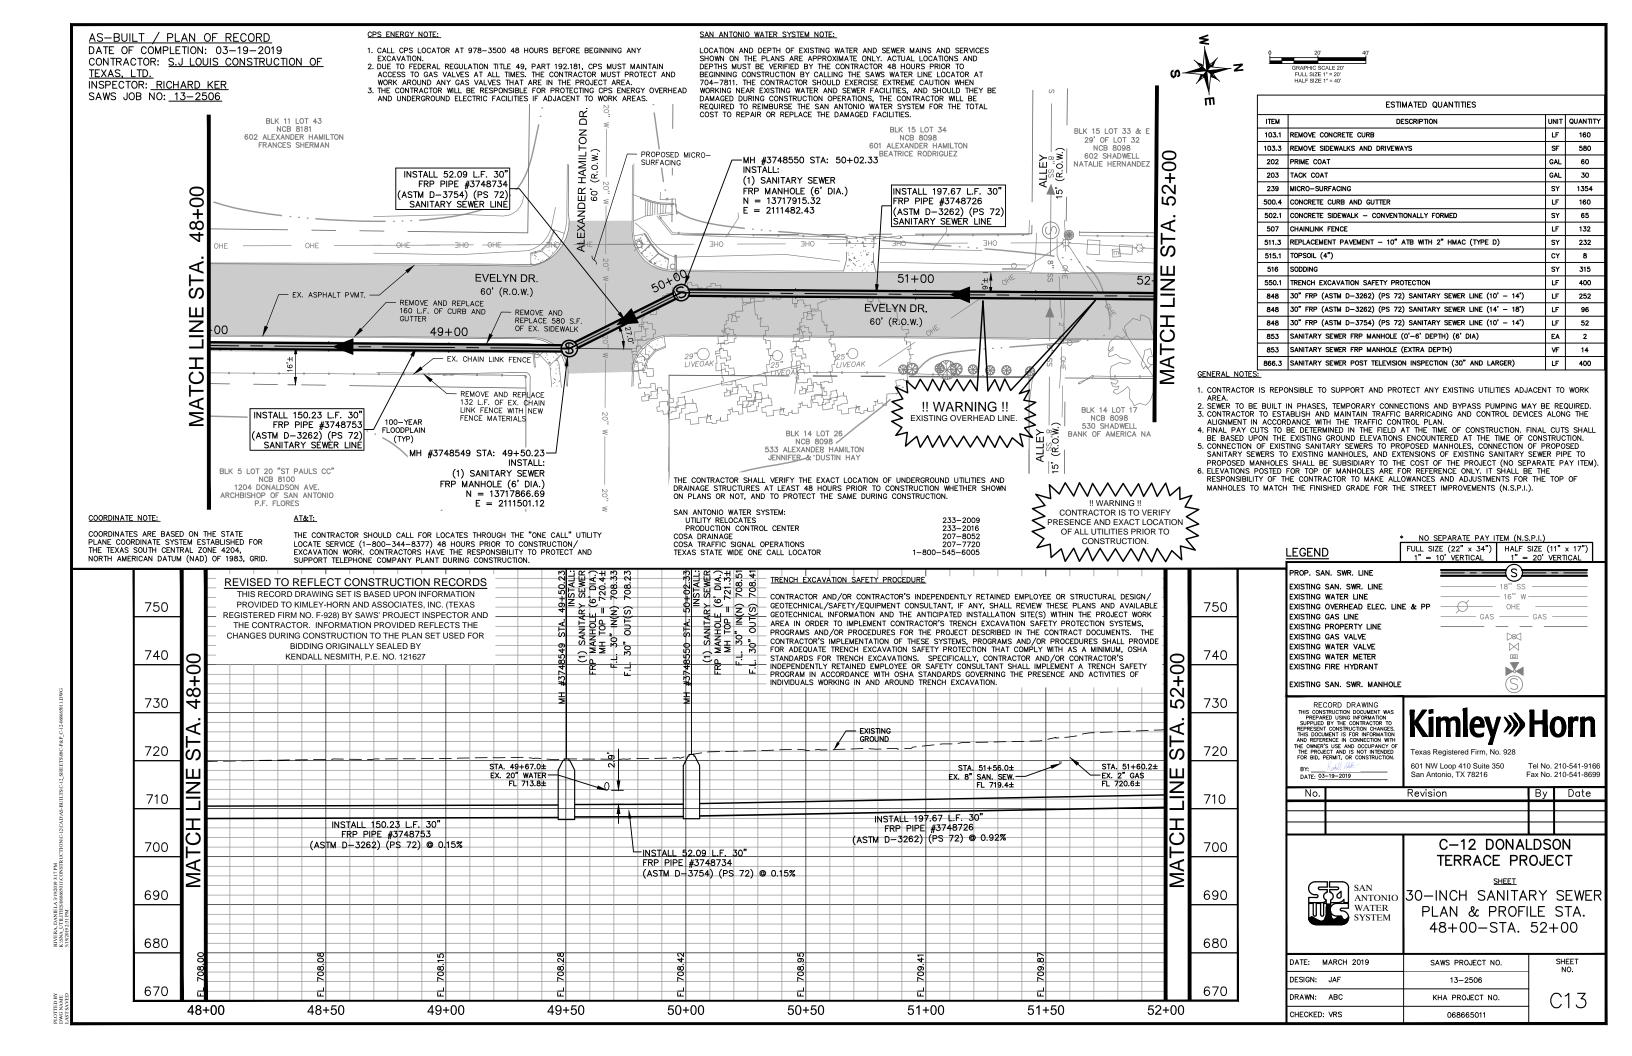


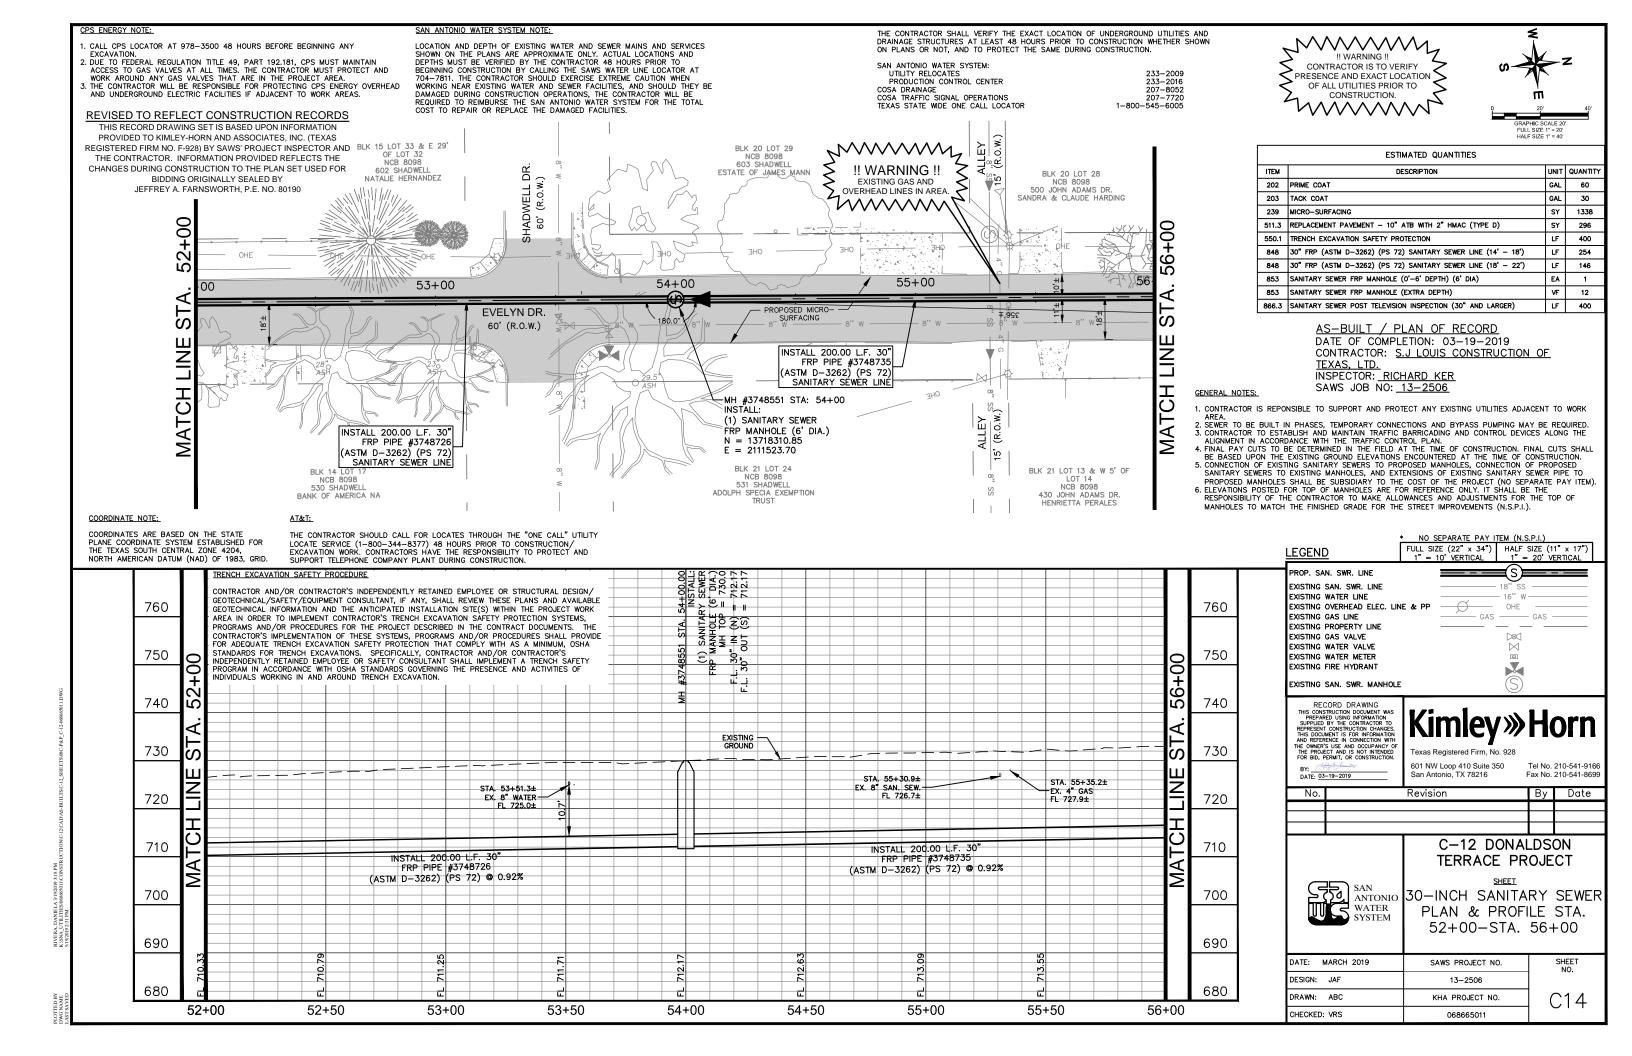


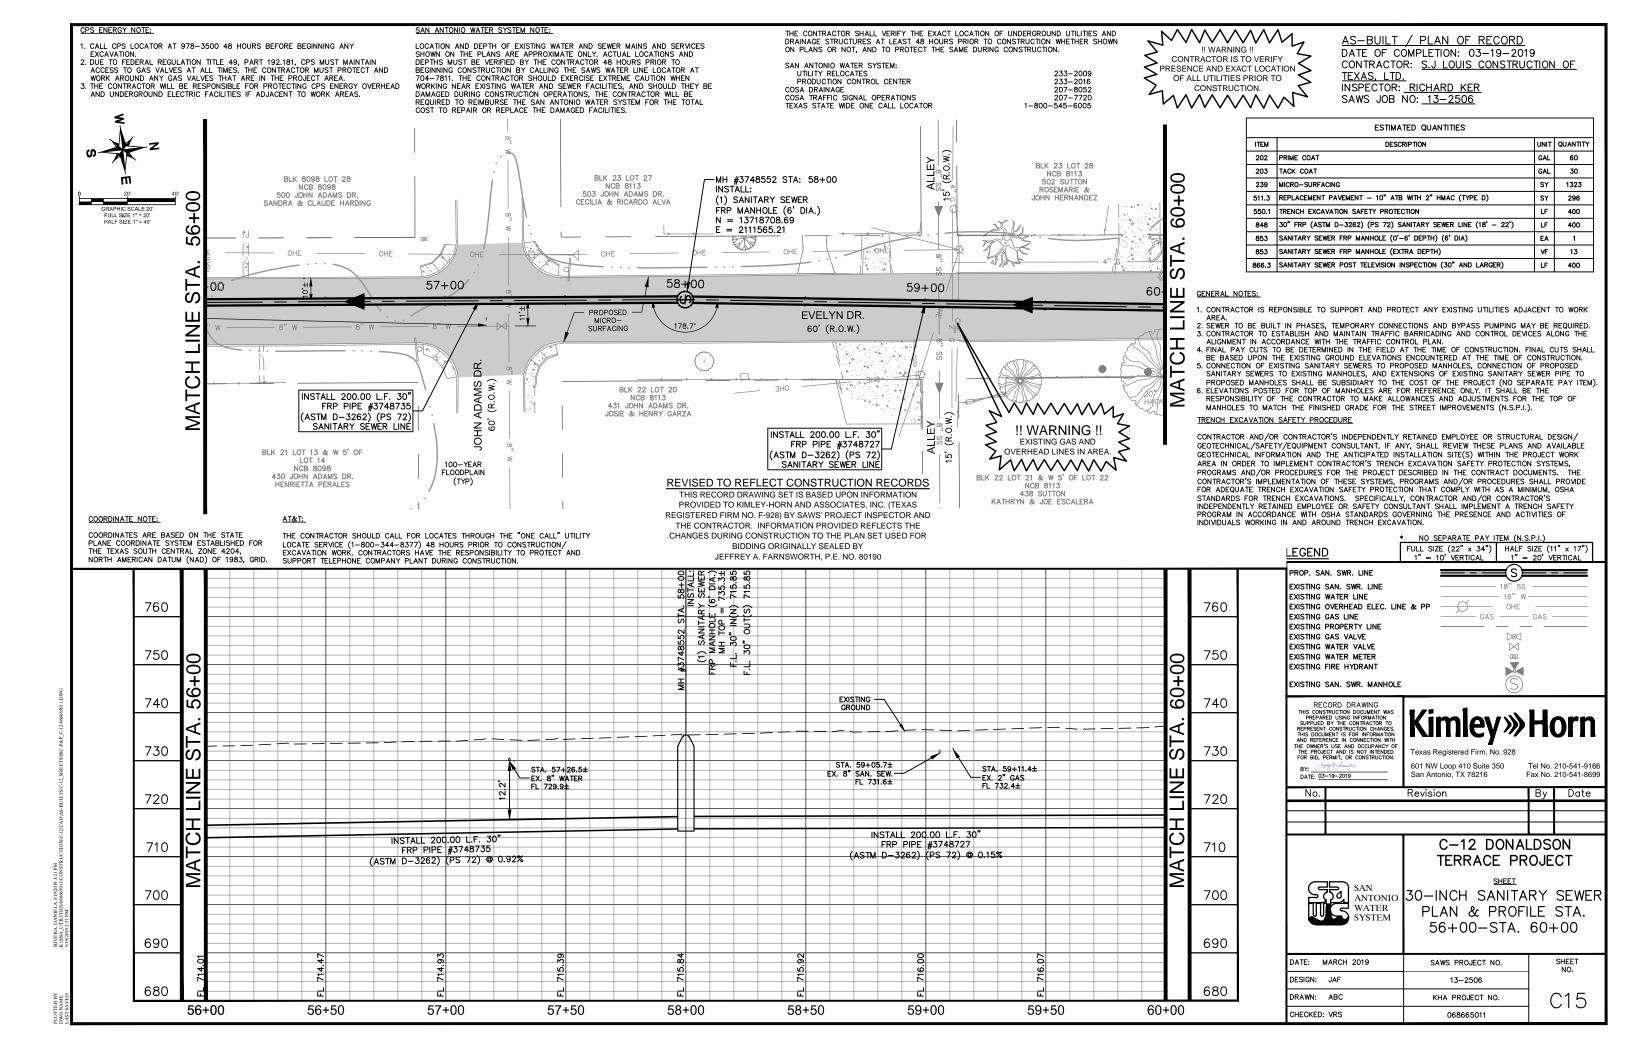


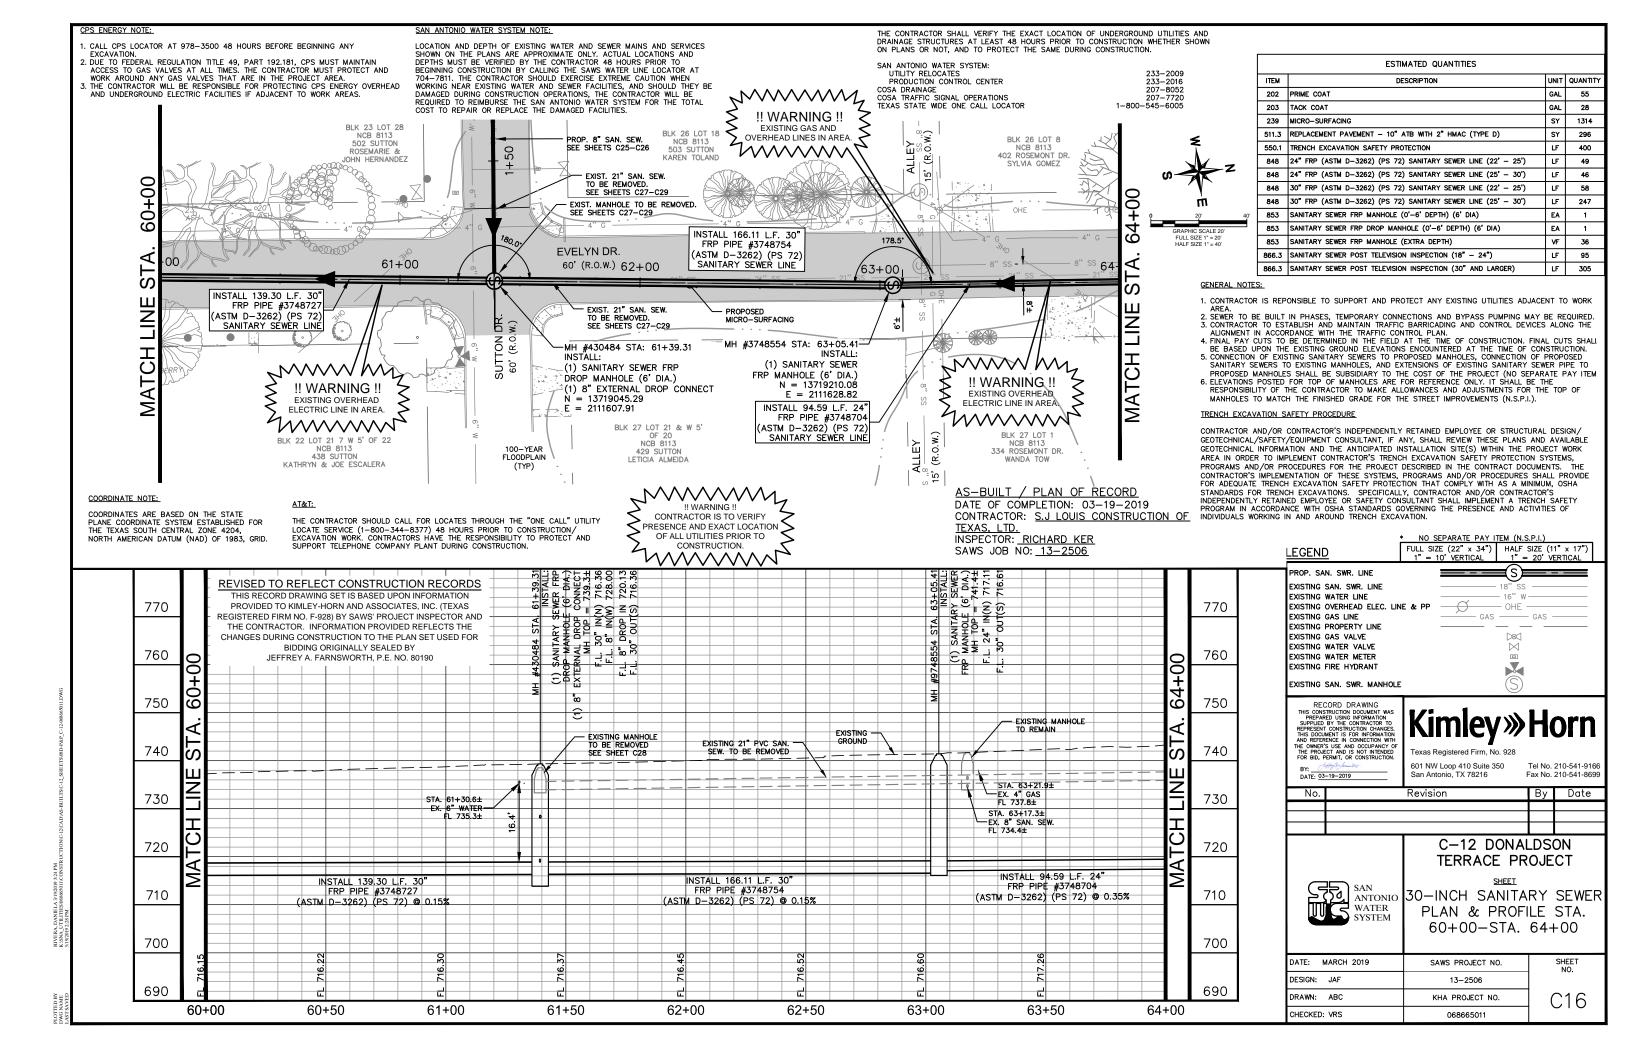


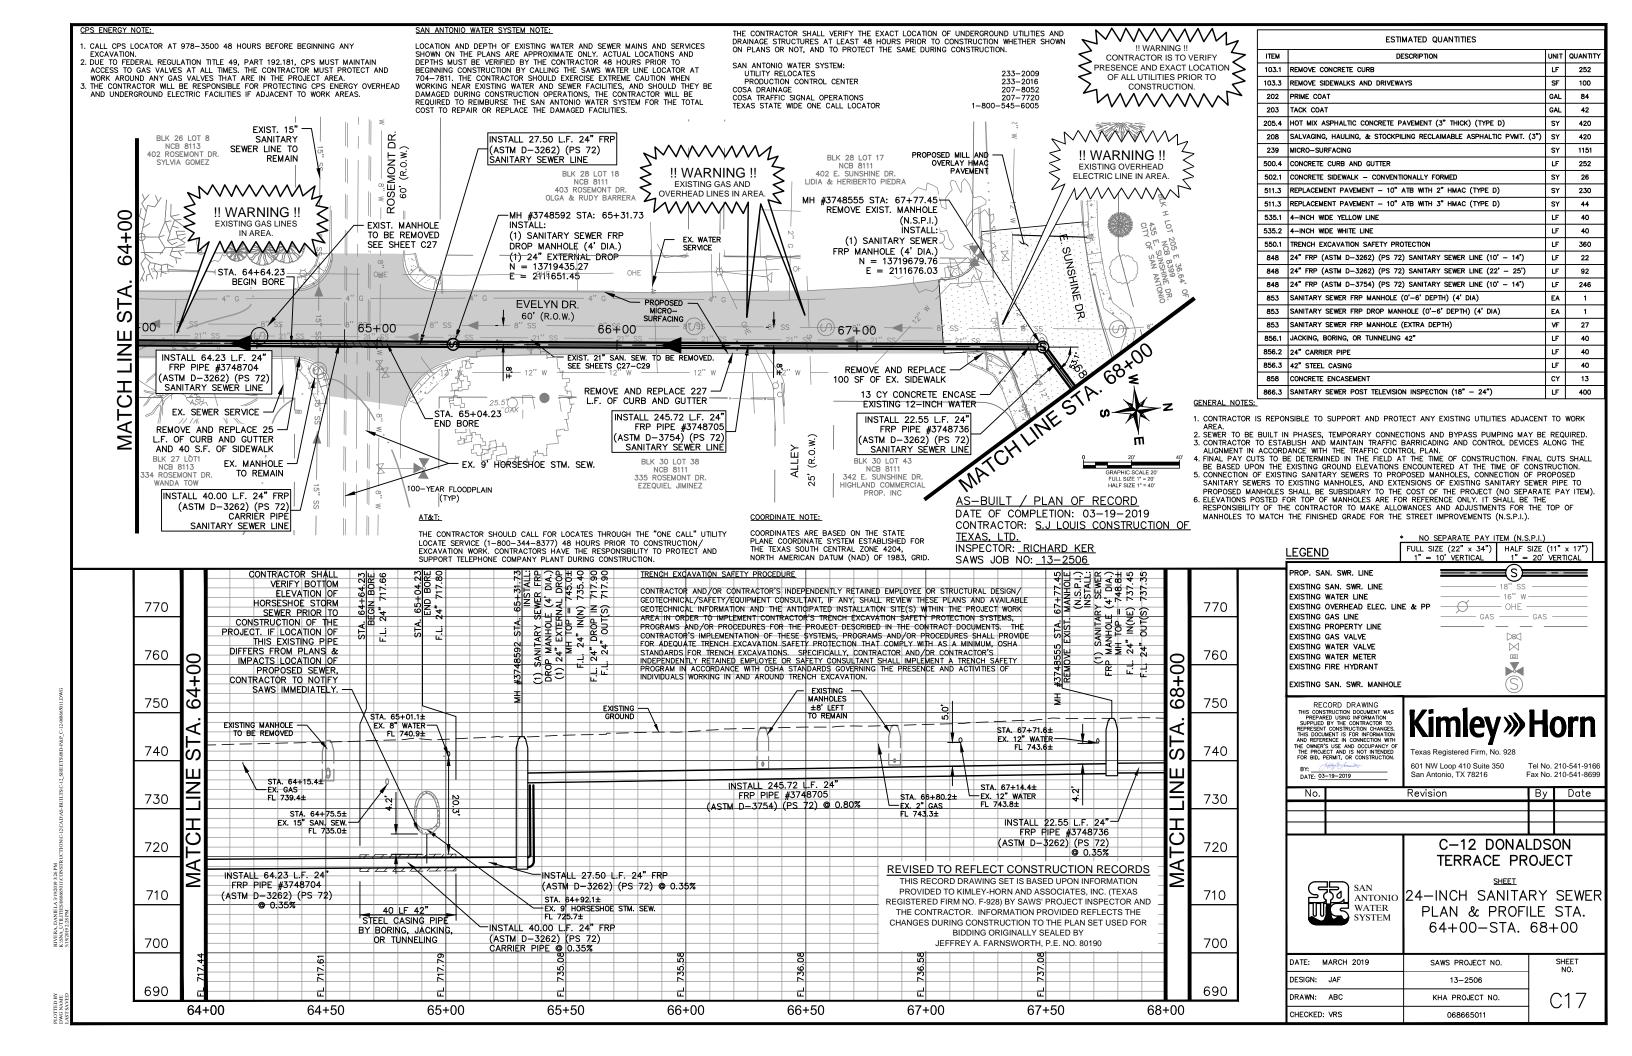


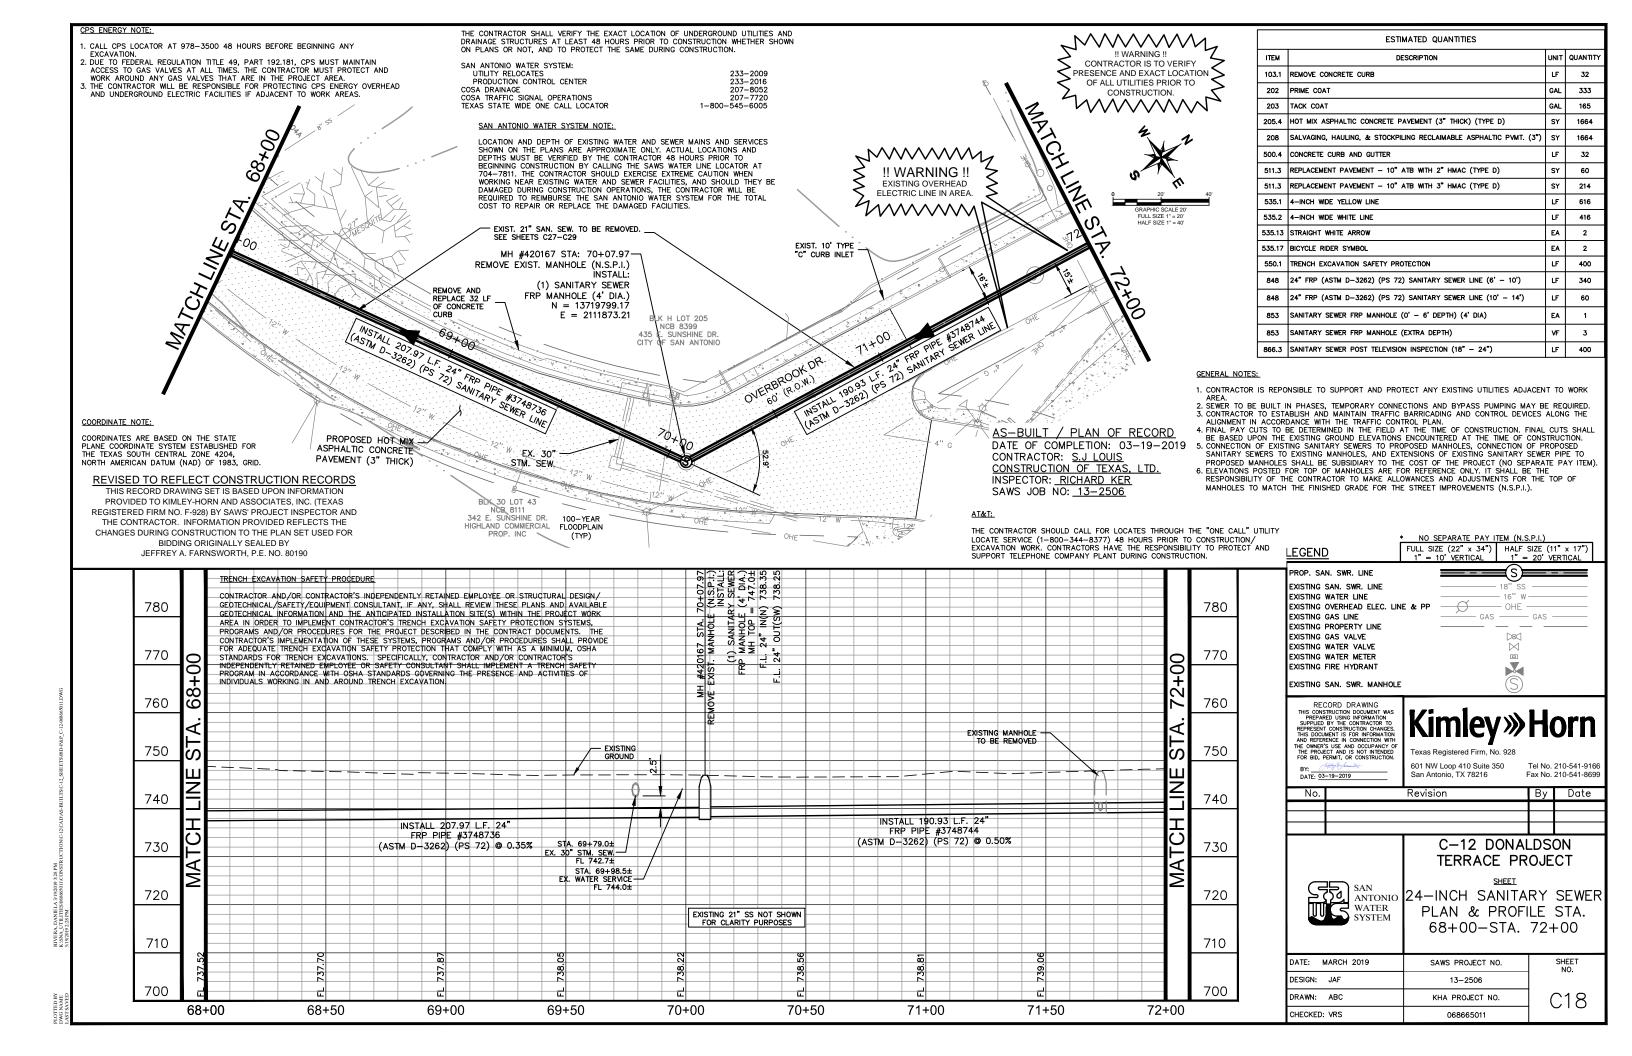


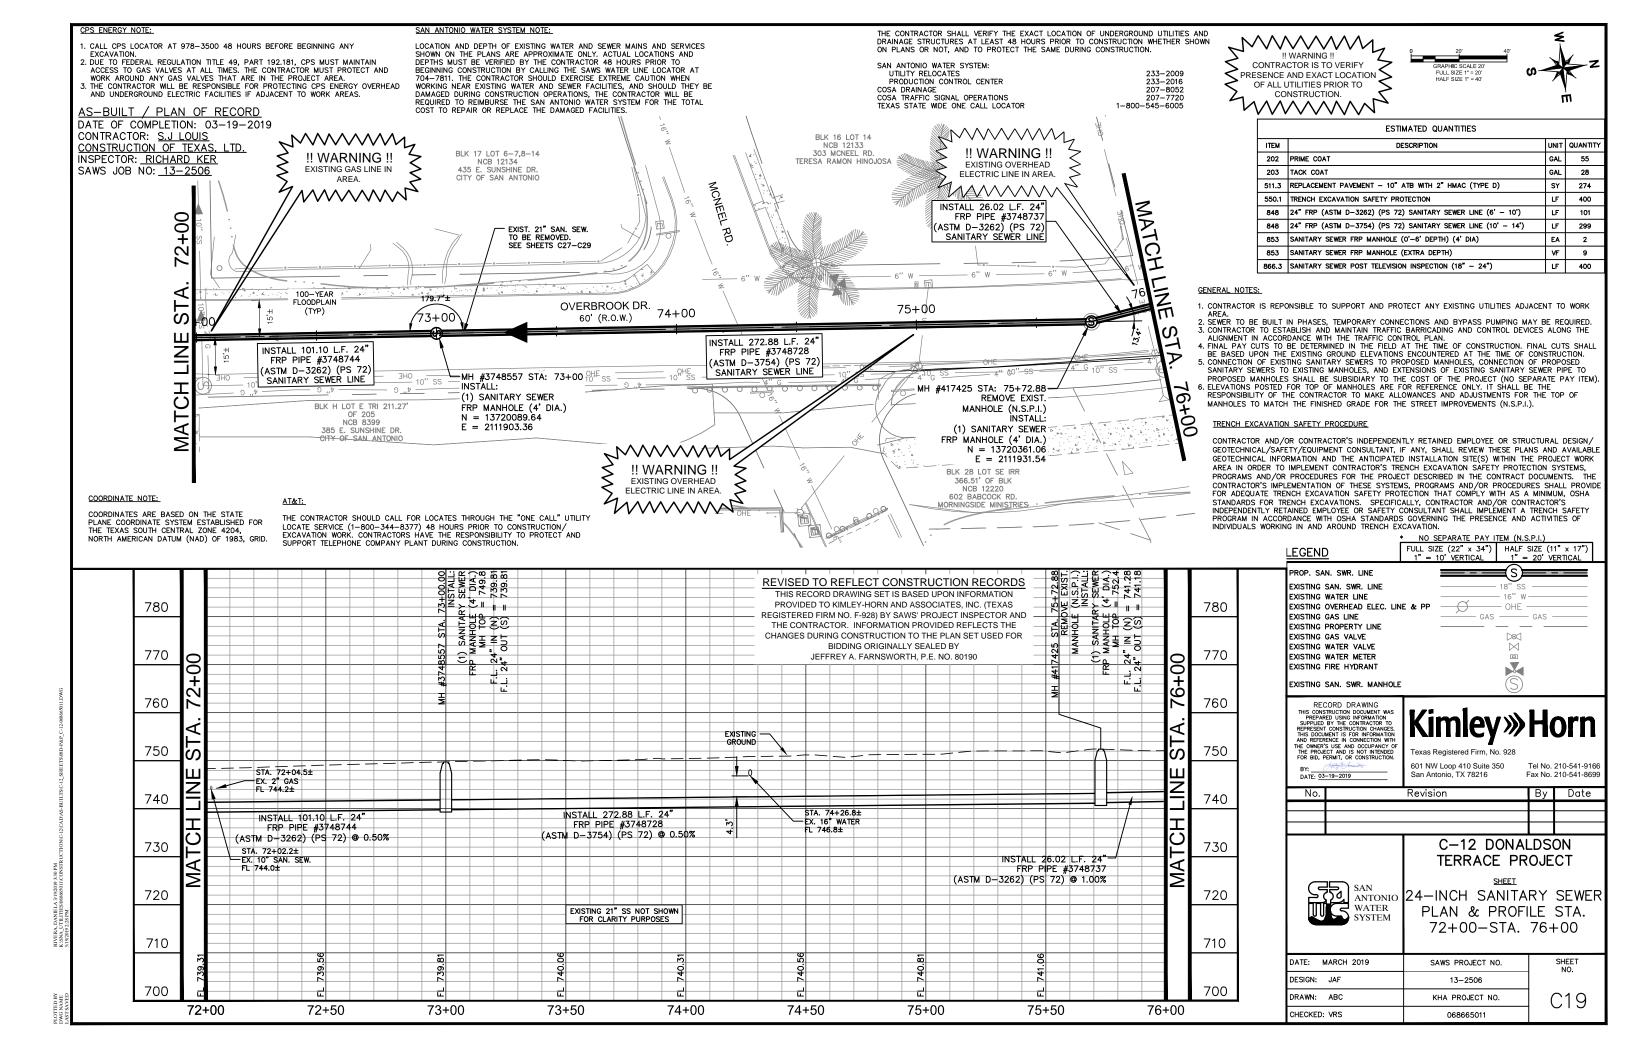


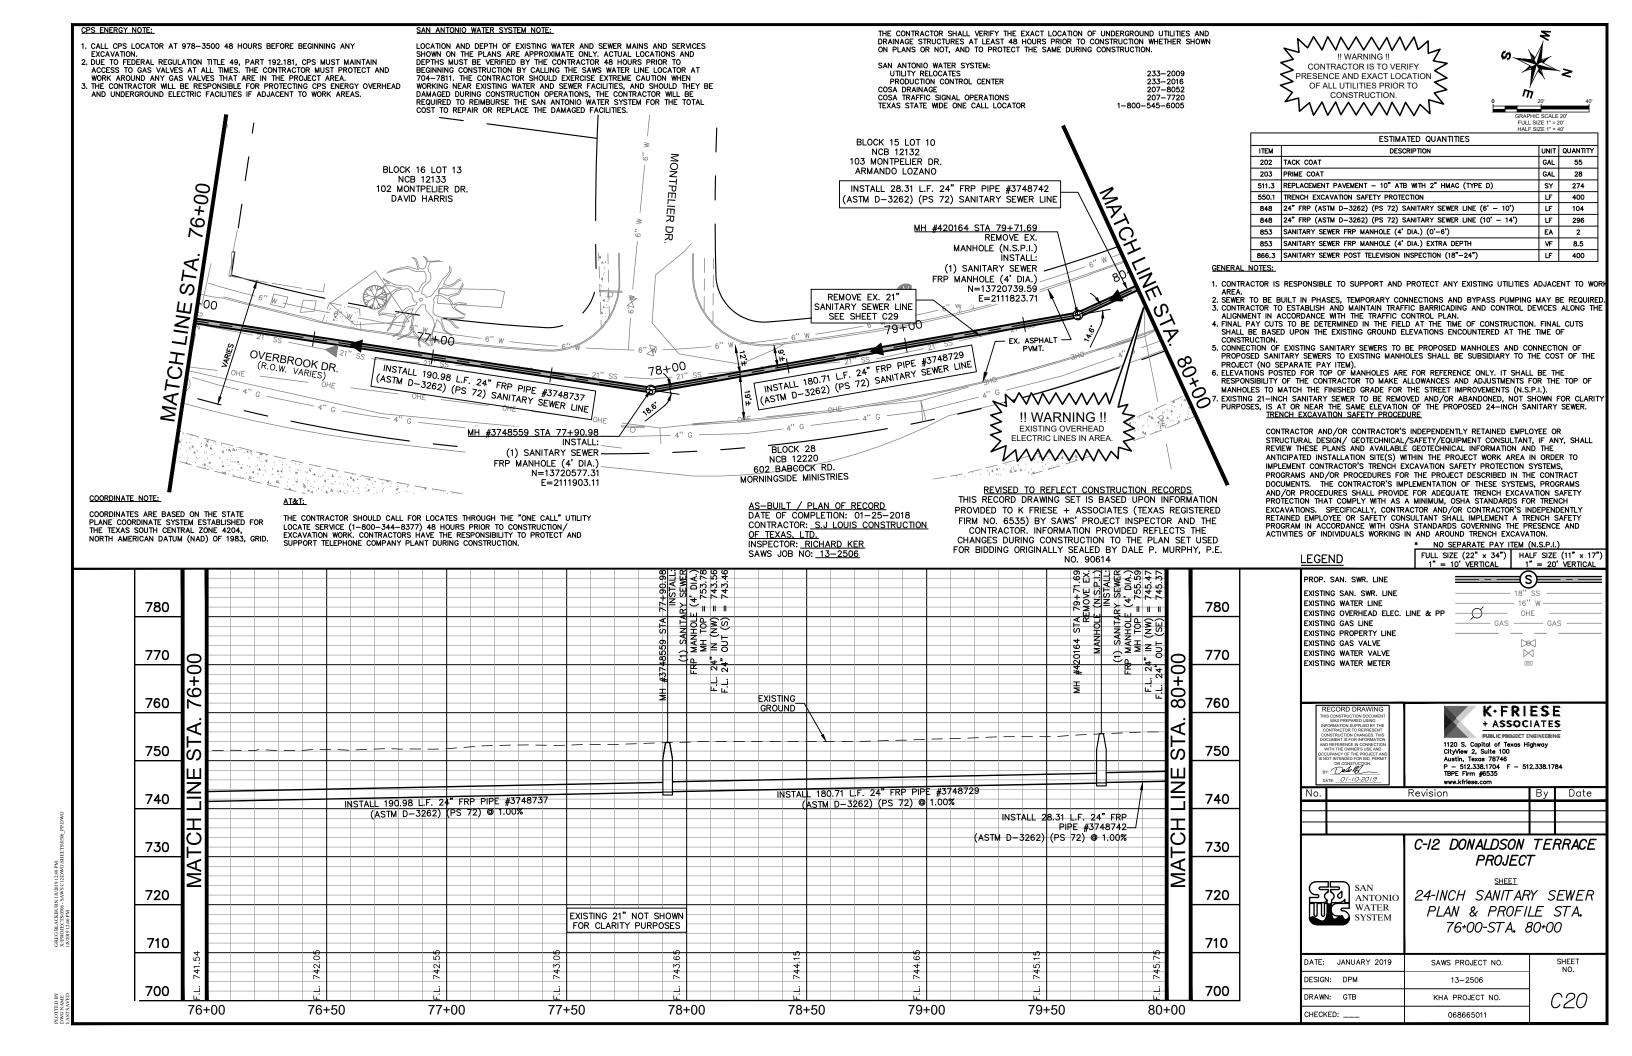


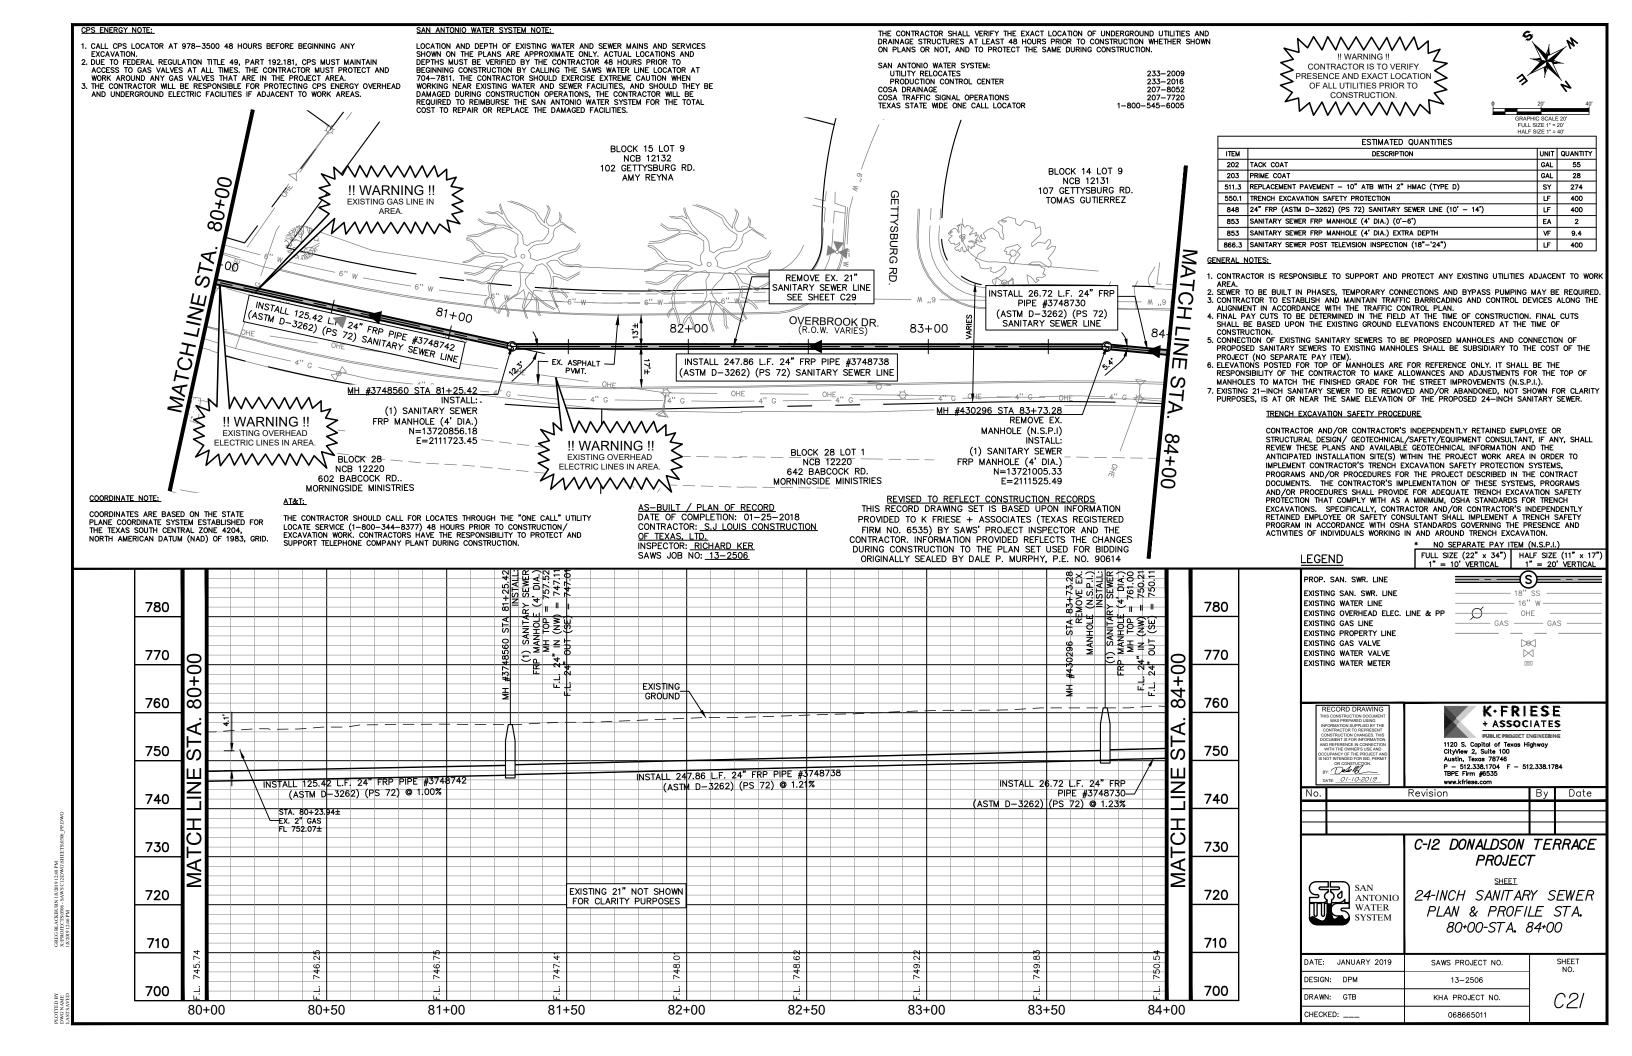


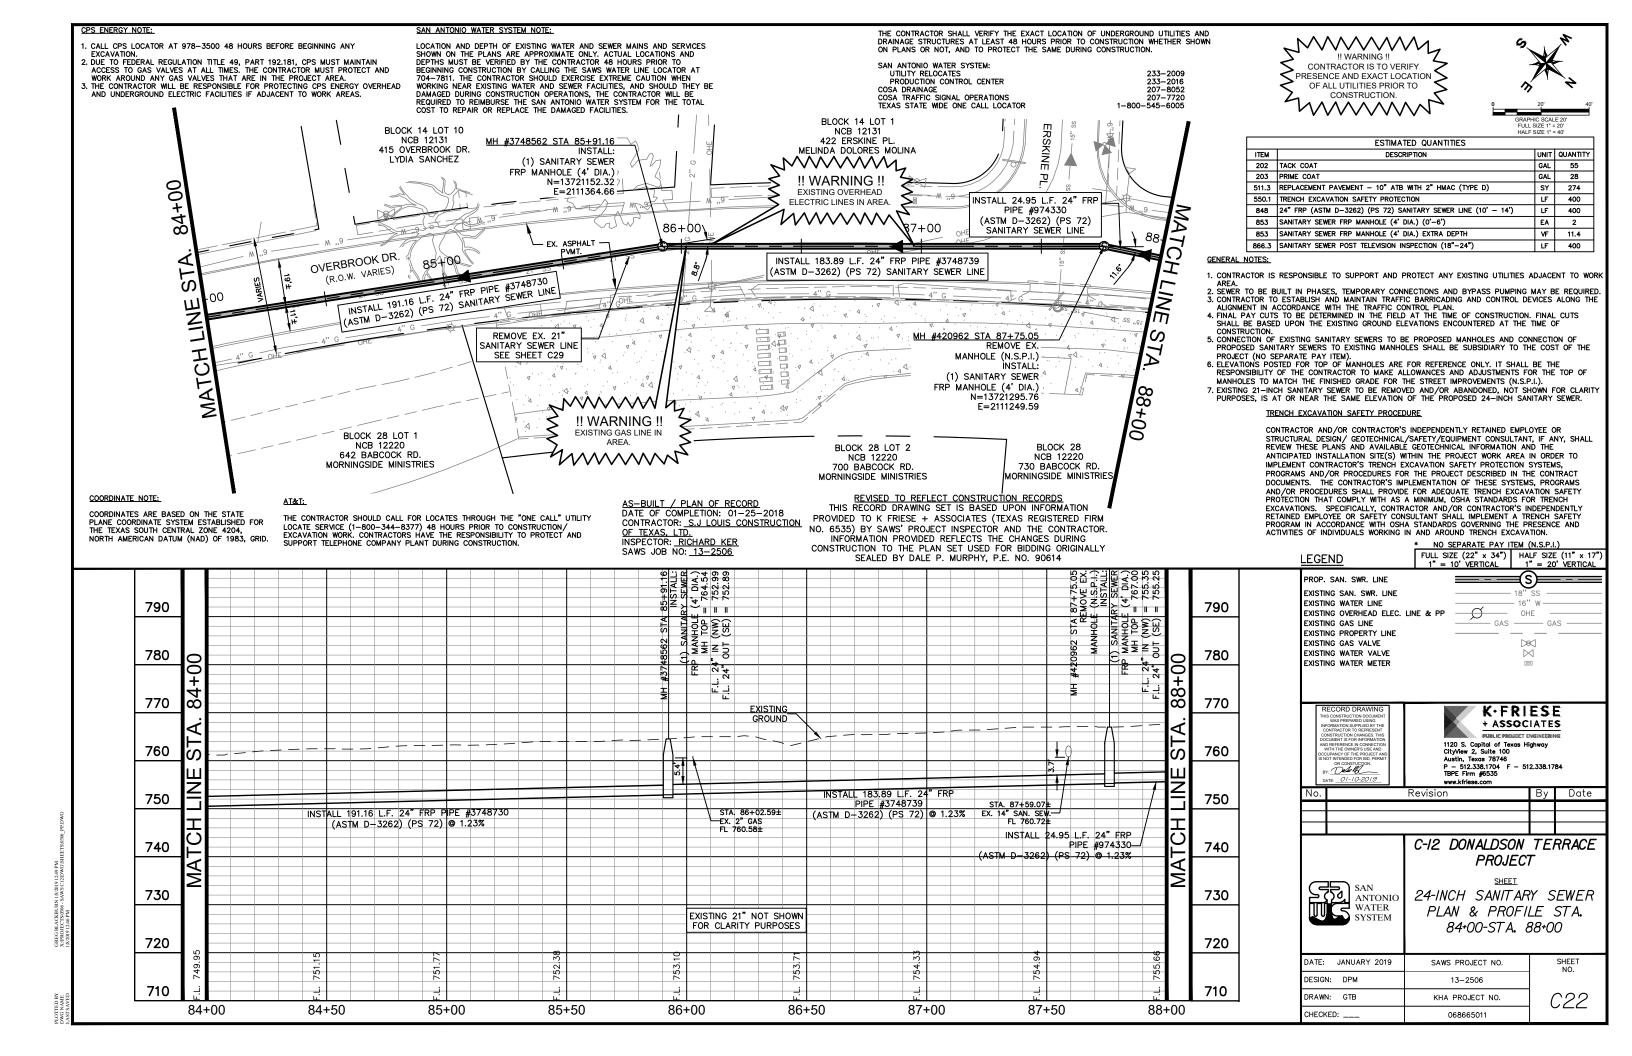


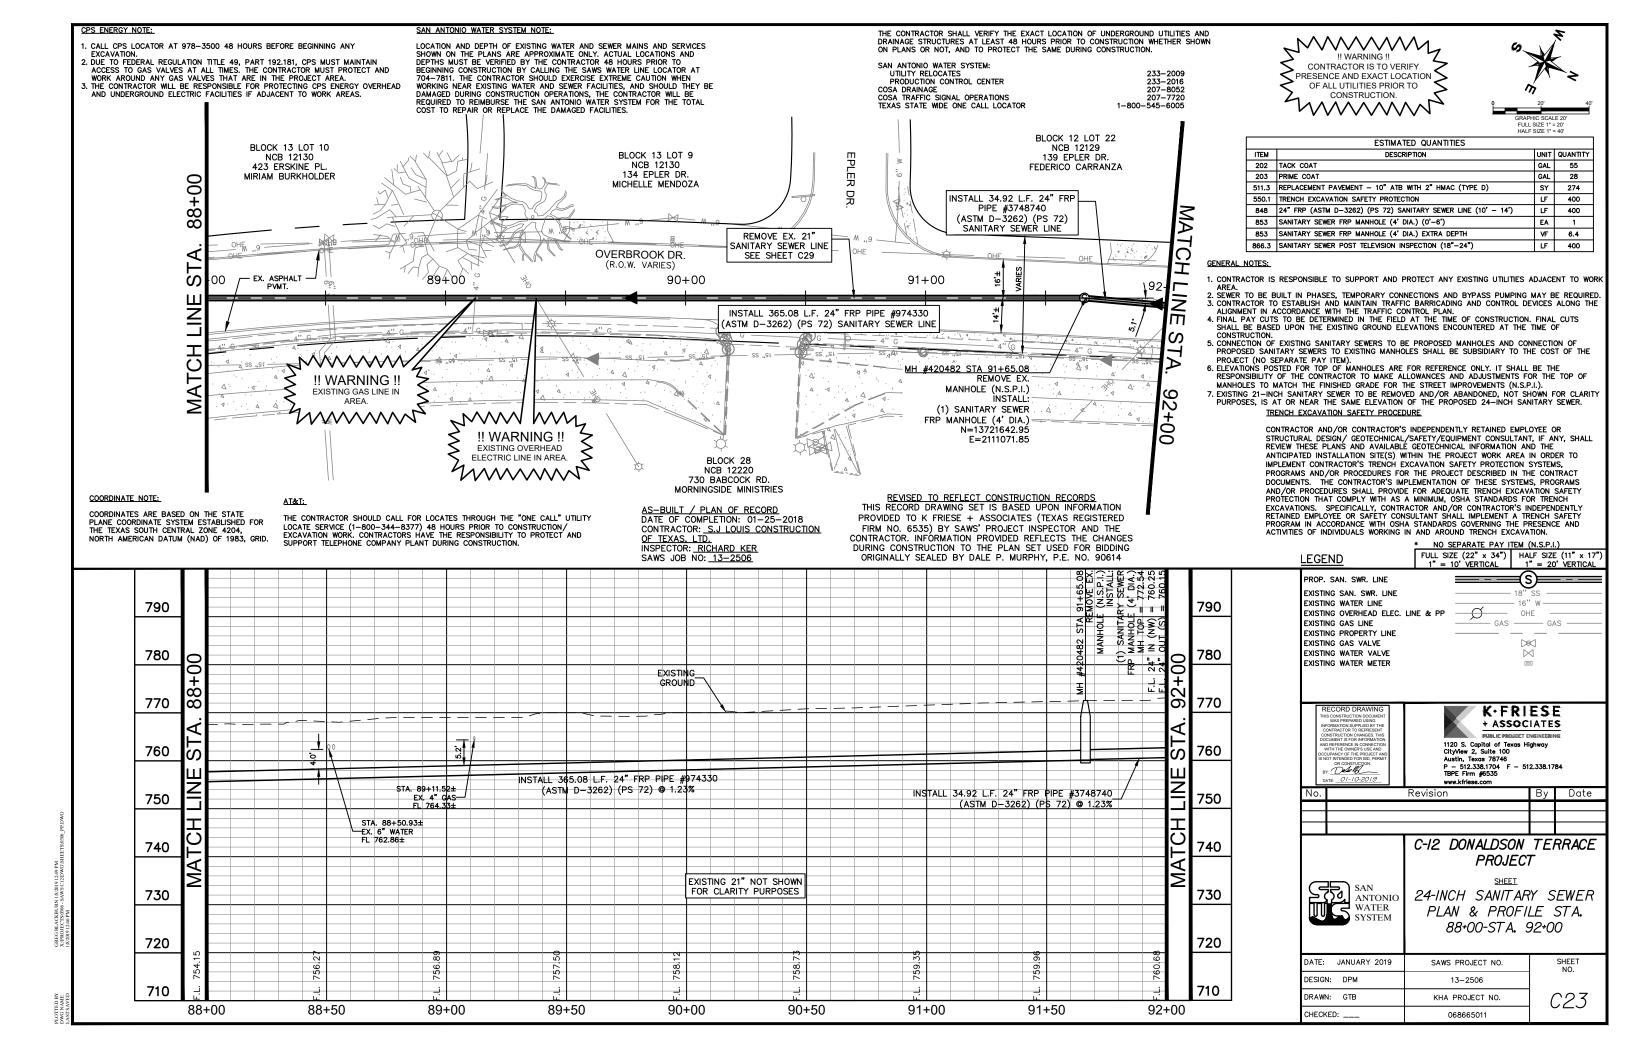


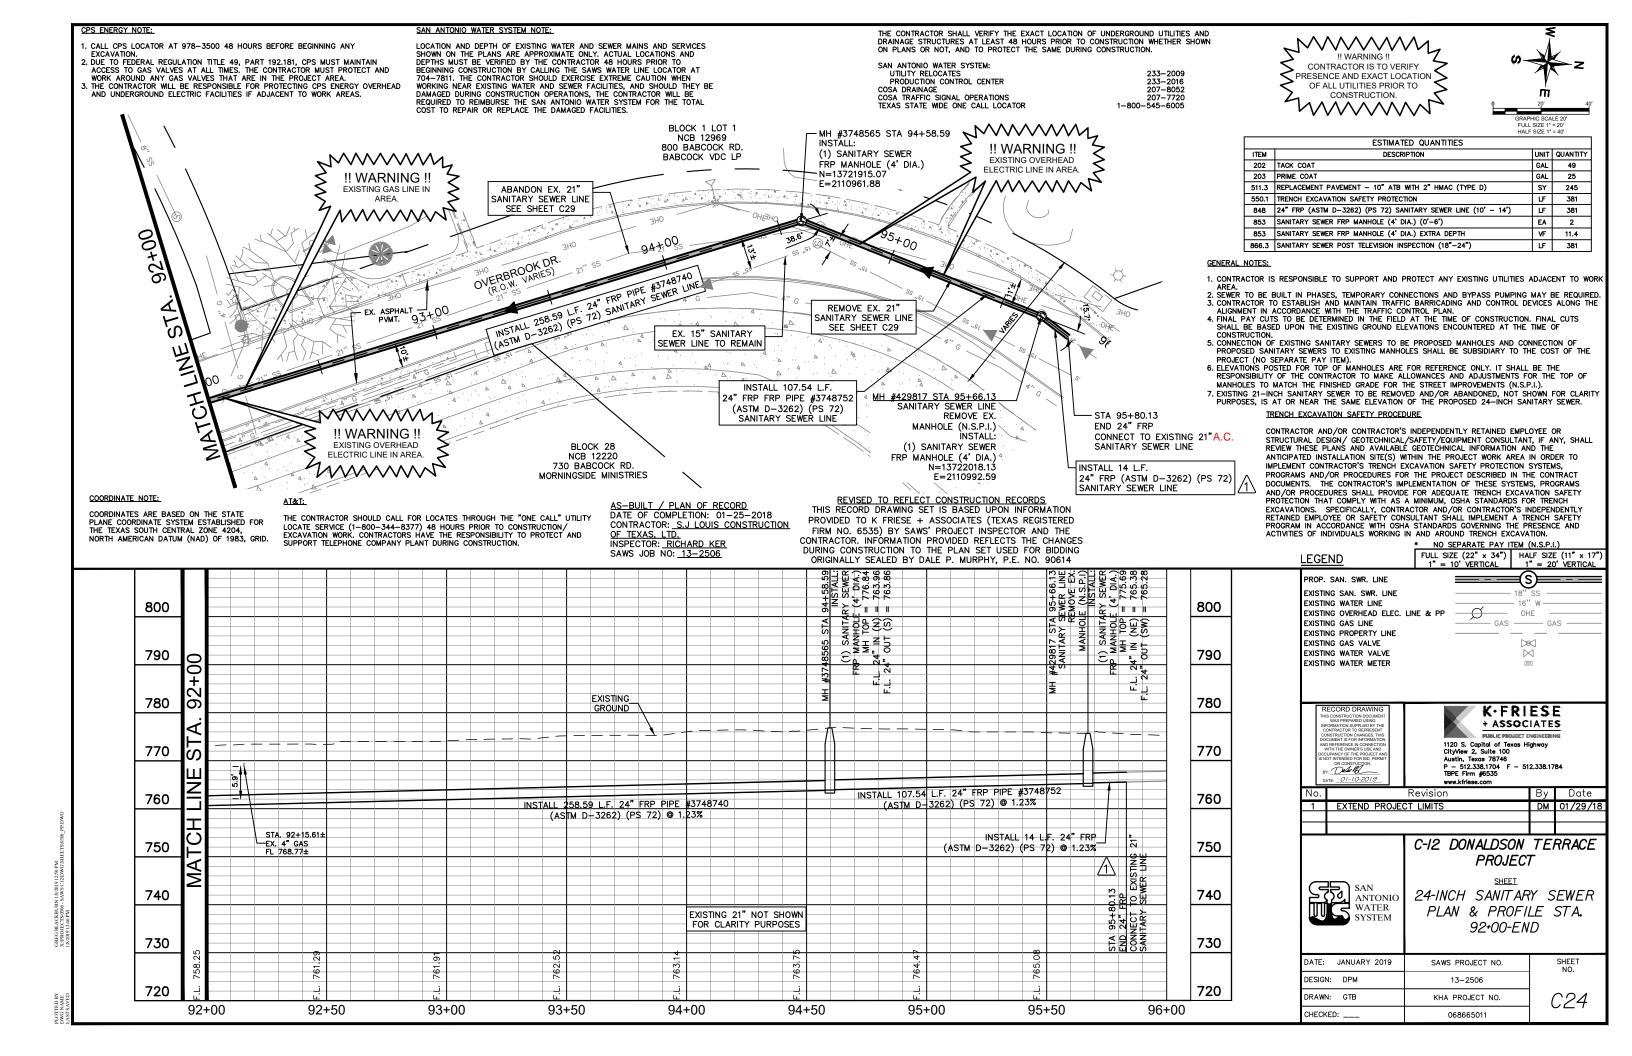


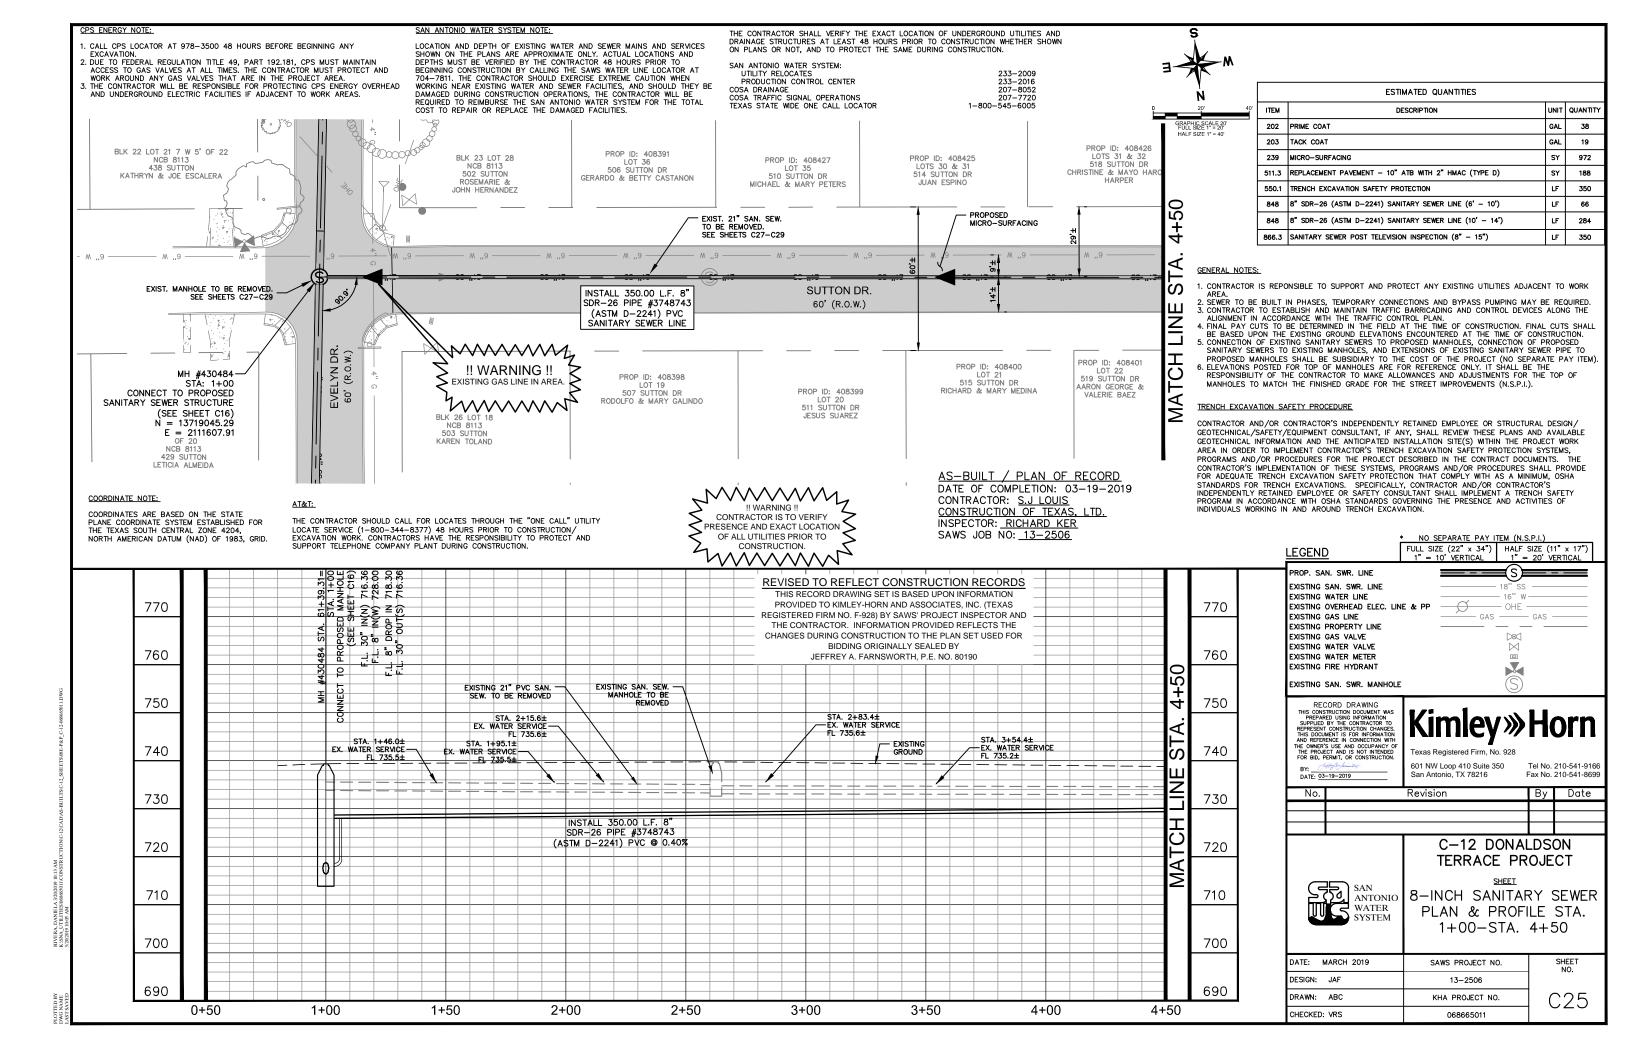

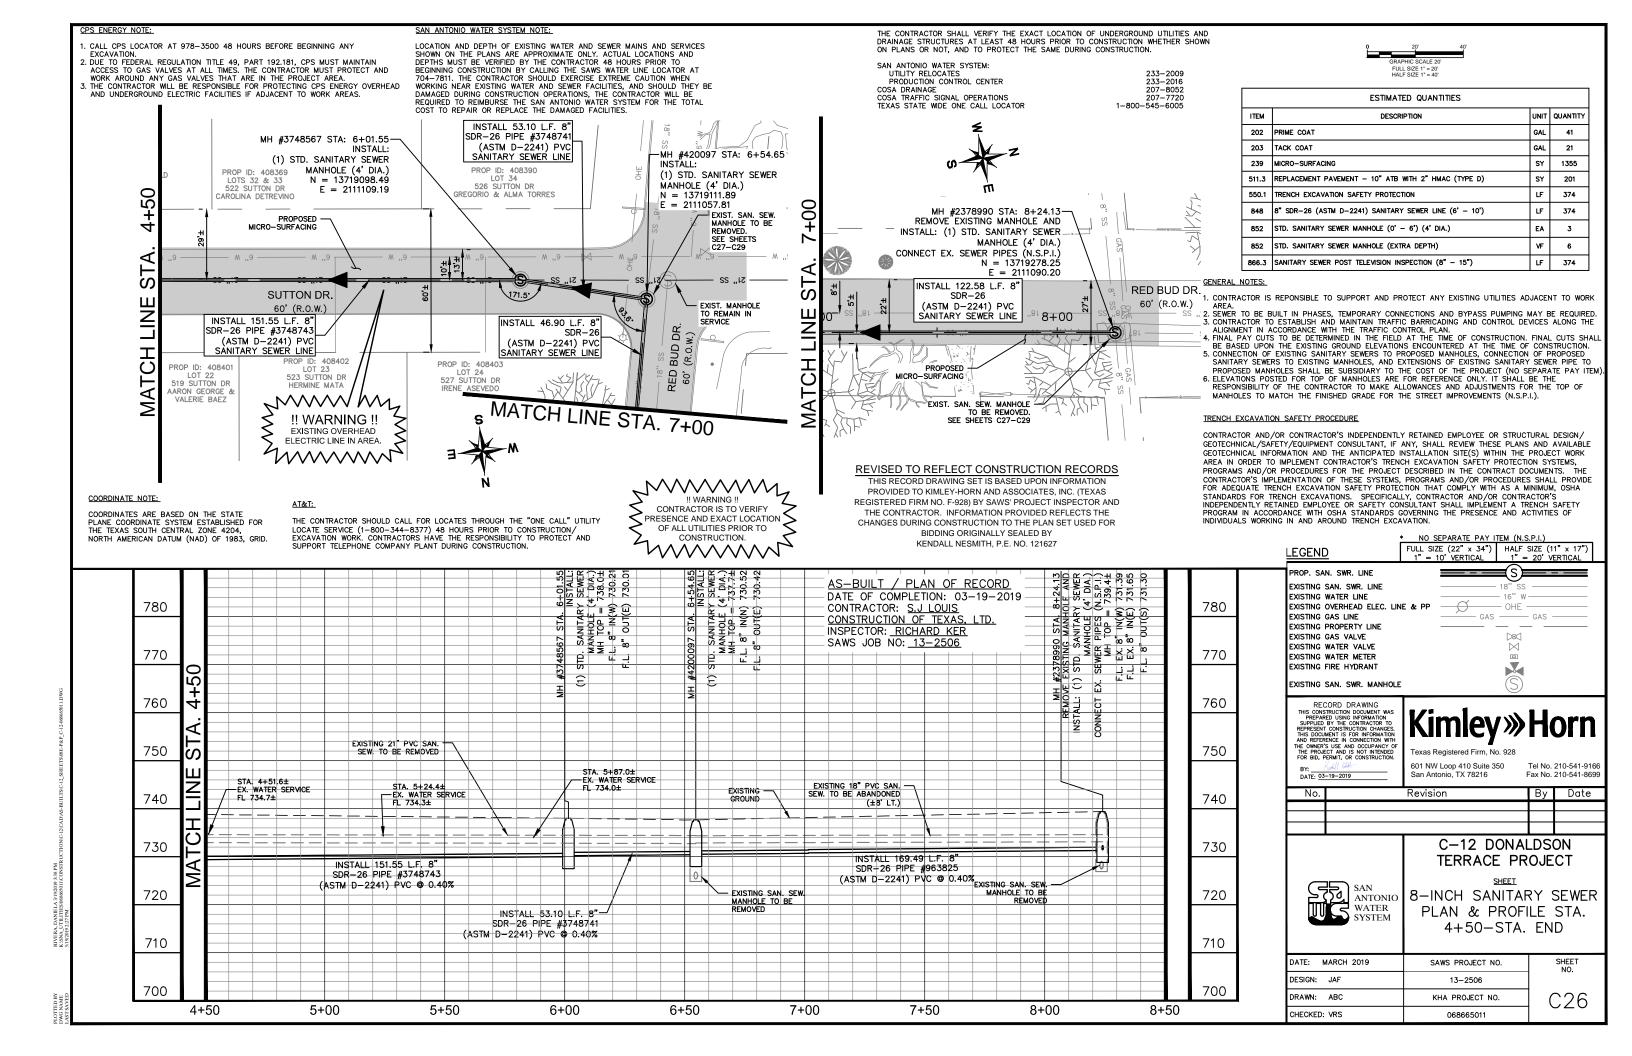

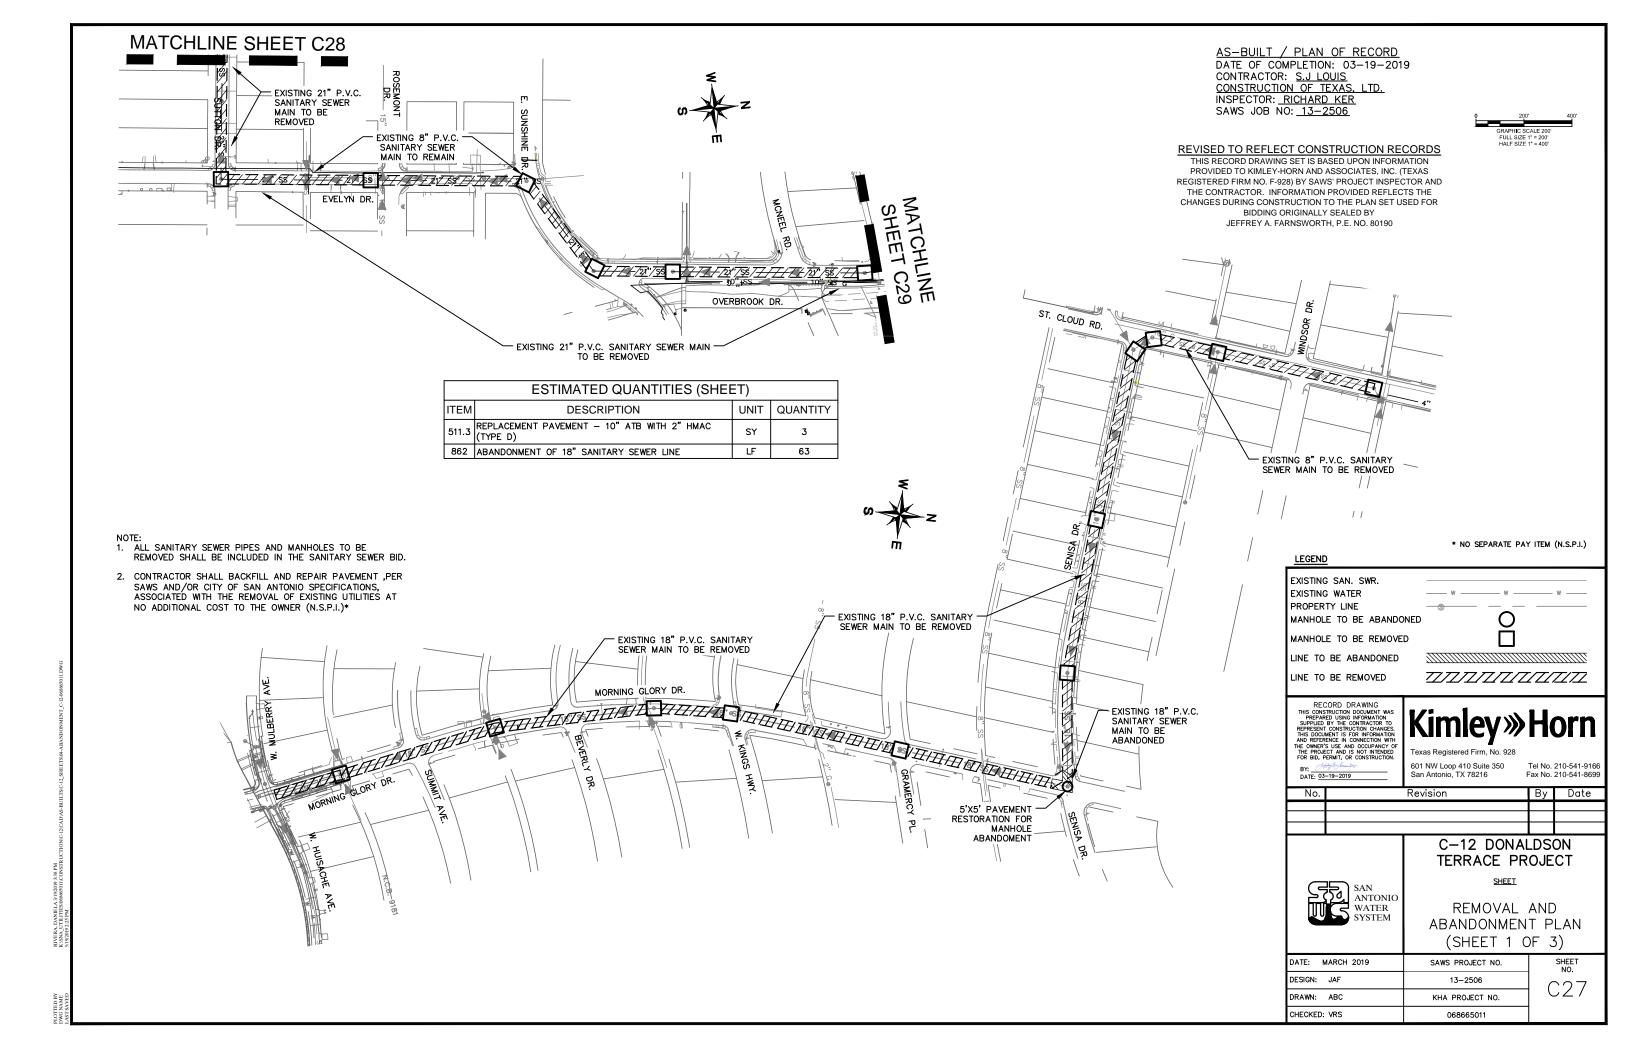

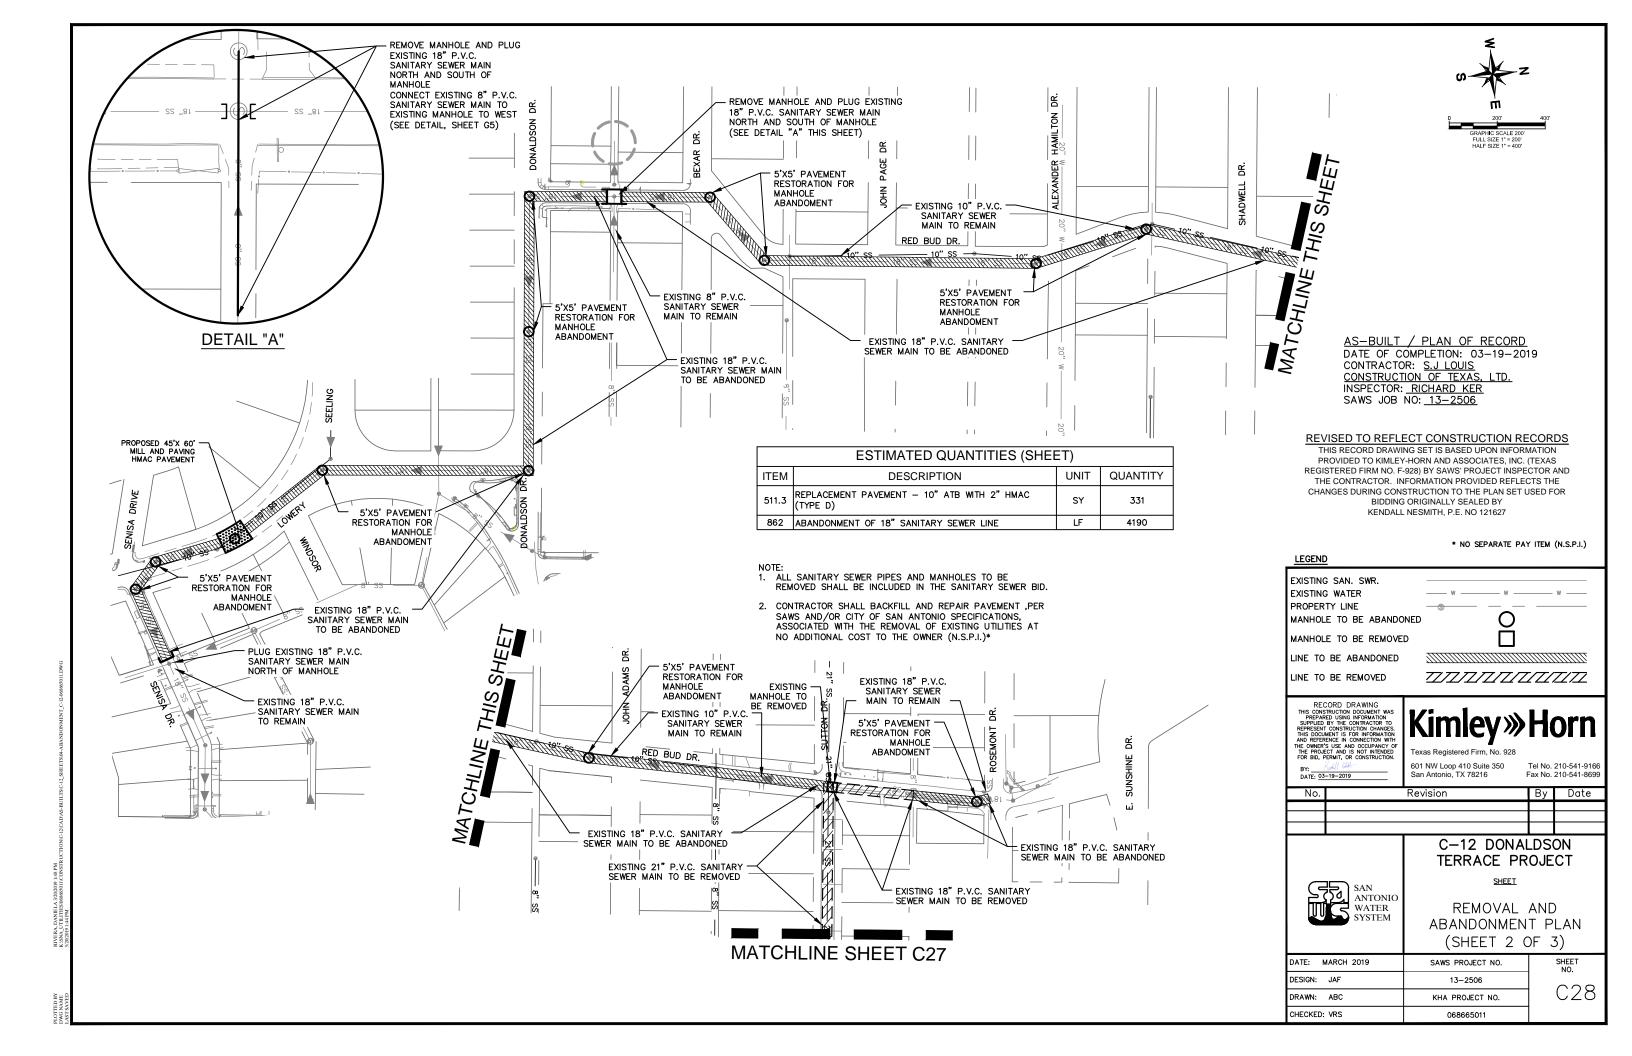

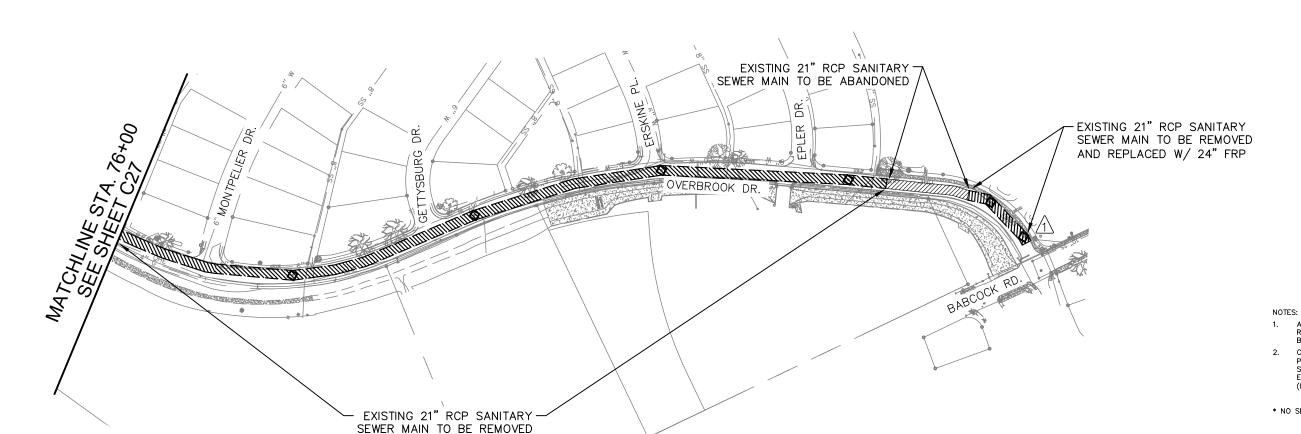



- ALL SANITARY SEWER PIPES AND MANHOLES TO BE REMOVED SHALL BE INCLUDED IN THE SANITARY SEWER BID.
- CONTRACTOR SHALL BACKFILL AND REPAIR PAVEMENT, PER SAWS AND/OR CITY OF SAN ANTONIO
 SPECIFICATIONS, ASSOCIATED WITH THE REMOVAL OF
 EXISTING UTILITIES AT NO COST TO THE OWNER
- * NO SEPARATE PAY ITEM (N.S.P.I.)

AS-BUILT / PLAN OF RECORD
DATE OF COMPLETION: 01-25-2018
CONTRACTOR: _S.J LOUIS CONSTRUCTION
OF TEXAS, LTD.
INSPECTOR: RICHARD KER
SAWS JOB NO: 13-2506

REVISED TO REFLECT CONSTRUCTION RECORDS
THIS RECORD DRAWING SET IS BASED UPON INFORMATION PROVIDED TO K FRIESE + ASSOCIATES (TEXAS REGISTERED FIRM NO. 6535) BY SAWS' PROJECT INSPECTOR AND THE CONTRACTOR. INFORMATION PROVIDED REFLECTS THE CHANGES DURING CONSTRUCTION TO THE PLAN SET USED FOR BIDDING ORIGINALLY SEALED BY DALE P. MURPHY, P.E. NO. 90614

AND REPLACED W/ 24" FRP

ESTIMATED QUANTITIES (SHEET)			
ITEM	DESCRIPTION	UNIT	QUANTITY
862	ABANDONMENT OF 21" SANITARY SEWER LINE	LF	172

LEGEND EXISTING SAN. SWR. EXISTING WATER PROPERTY LINE 0 MANHOLE TO BE ABANDONED MANHOLE TO BE REMOVED LINE TO BE ABANDONED

PANCY UP
JT INTENDED FOR BILL
OR CONSTUCTION
BY:

LINE TO BE REMOVED

K.FRIESE + ASSOCIATES

1120 S. Capital of Texas Highway CityView 2, Suite 100 Austin, Texas 78746 P - 512.338.1704 F - 512.338.1784 TBPE Firm #6535 www.kfriese.com

No.	Revision	Ву	Date	
1	EXTEND PROJECT LIMITS	DM	01/29/18	



C-12 DONALDSON TERRACE **PROJECT**

(SHEET 3 OF 3)

SHEET REMOVAL AND ABANDONMENT PLAN

DATE: JANUARY 2019 SAWS PROJECT NO. DESIGN: DPM 13-2506 C29 DRAWN: GTB KHA PROJECT NO. CHECKED: __ 068665011